
GENERAL NOTES


- ALL WORK SHALL COMPLY TO THE FOLLOWING CODES: 2019 CALIFORNIA BUILDING. (CBC), 2019 CALIFORNIA RESIDENTIAL CODE ("CRC"). 2019 CALIFORNIA ELECTRICAL CODE ("CEC"), 2019 CALIFORNIA FIRE CODE ("CFC"), 2019 CALIFORNIA MECHANICAL CODE ("CMC"), CALIFORNIA PLUMBING CODE ("CPC") 2019 CALIFORNIA GREEN BUILDING (CGB) AND 2019 CALIFORNIA ENERGY CODE (CEC.)
- DIMENSIONS ARE TO FACE OF STUD, U.O.N.
- 3. DO NOT SCALE DIMENSIONS; WRITTEN DIMENSIONS TAKE PRECEDENCE OVER SCALED DIMENSIONS.
- ALIGN THE WINDOW HEADS WITH TOP OF DOORS AT 6'-8" A.F.F., U.O.N.
- CONTRACTOR SHALL BE RESPONSIBLE FOR PROVIDING ALL WORK AND MATERIAL IN ACCORDANCE WITH ALL LOCAL AND/OR CITY
- 6. CONTRACTOR SHALL VERIFY ALL FIELD DIMENSIONS AND CONDITIONS AND REPORT DISCREPANCIES TO THE DESIGNER.
- DIMENSIONS ARE NOT ADJUSTABLE WITHOUT APPROVAL OF THE DESIGNER.
- CONTRACTOR SHALL THOROUGHLY EXAMINE THE PREMISE AND SHALL BASE HIS BID ON THE EXISTING CONDITIONS, NOT
- WITHSTANDING ANY INFORMATION SHOWN OR NOT SHOWN ON DRAWING.
- THE GENERAL CONTRACTOR IS RESPONSIBLE FOR CHECKING CONTRACT DOCUMENTS. FIELD VERIFY CONDITIONS AND DIMENSIONS FOR ACCURACY, CONFIRM THE WORK CAN BE BUILT AS SHOWN BEFORE PROCEEDING WITH THE WORK, IF THERE ARE ANY QUESTIONS REGARDING THESE OR OTHER COORDINATION QUESTIONS, THE GENERAL CONTRACTOR IS RESPONSIBLE FOR OBTAINING A CLARIFICATIONS FROM THE ARCHITECT BEFORE PROCEEDING WITH THE RELATED WORK IN QUESTION.
- 10. "SIMILAR" MEANS COMPARABLE CHARACTERISTICS FOR ITEMS NOTED. VERIFY DIMENSIONS AND ORIENTATION ON PLAN.
- 11. "TYPICAL" OR "TYP" MEANS IDENTICAL FOR ALL SIMILAR CONDITIONS UNLESS OTHERWISE NOTED.
- 12. DIMENSIONS NOTED "CLEAR" OR "CLR" ARE MINIMUM REQUIRED DIMENSIONS AND CLEARANCES AND MUST BE ACCURATELY
- 13. GENERAL CONTRACTOR TO COORDINATE INSTALLATION OF N.I.C. (NOT IN CONTRACT) ITEMS WITH OTHER TRADES.
- 14. IN ACCORDANCE WITH GENERALLY ACCEPTED CONSTRUCTION PRACTICES. THE CONTRACTOR WILL BE SOLELY AND COMPLETELY RESPONSIBLE FOR CONDITIONS OF THE JOB SITE; INCLUDING SAFETY OF ALL PERSONS AND PROPERTY DURING PERFORMANCE OF THE WORK. THIS REQUIREMENT WILL APPLY CONTINUOUSLY AND NOT BE LIMITED TO NORMAL WORKING HOURS.
- 15. THE CONTRACTOR SHALL PROVIDE EVERYTHING NECESSARY AND REASONABLY INCIDENTAL FOR THE PROPER AND WORKMANLIKE EXECUTION OF THE INTENT OF THE DRAWINGS, WHETHER SPECIFICALLY MENTIONED OR NOT.
- 16. CONTRACTOR SHALL BE RESPONSIBLE TO VERIFY ALL WINDOW SIZES PRIOR TO ORDERING. PROVIDE TEMPERED GLASS WHERE APPLICABLE AND COMPLY W/ ALL APPLICABLE CODES.
- 17. THE SITE SHALL BE KEPT IN A NEAT AND ORDERLY MANNER DURING THE COURSE OF CONSTRUCTION. 18. COORDINATE WITH THE OWNERS ALL UTILITY SHUT-DOWNS AS REQUIRED FOR UTILITY TIE-INS ETC.

CUSTOM RESIDENCE FERDINAND AVENUE

CONSULTANTS

ABBREVIATIONS

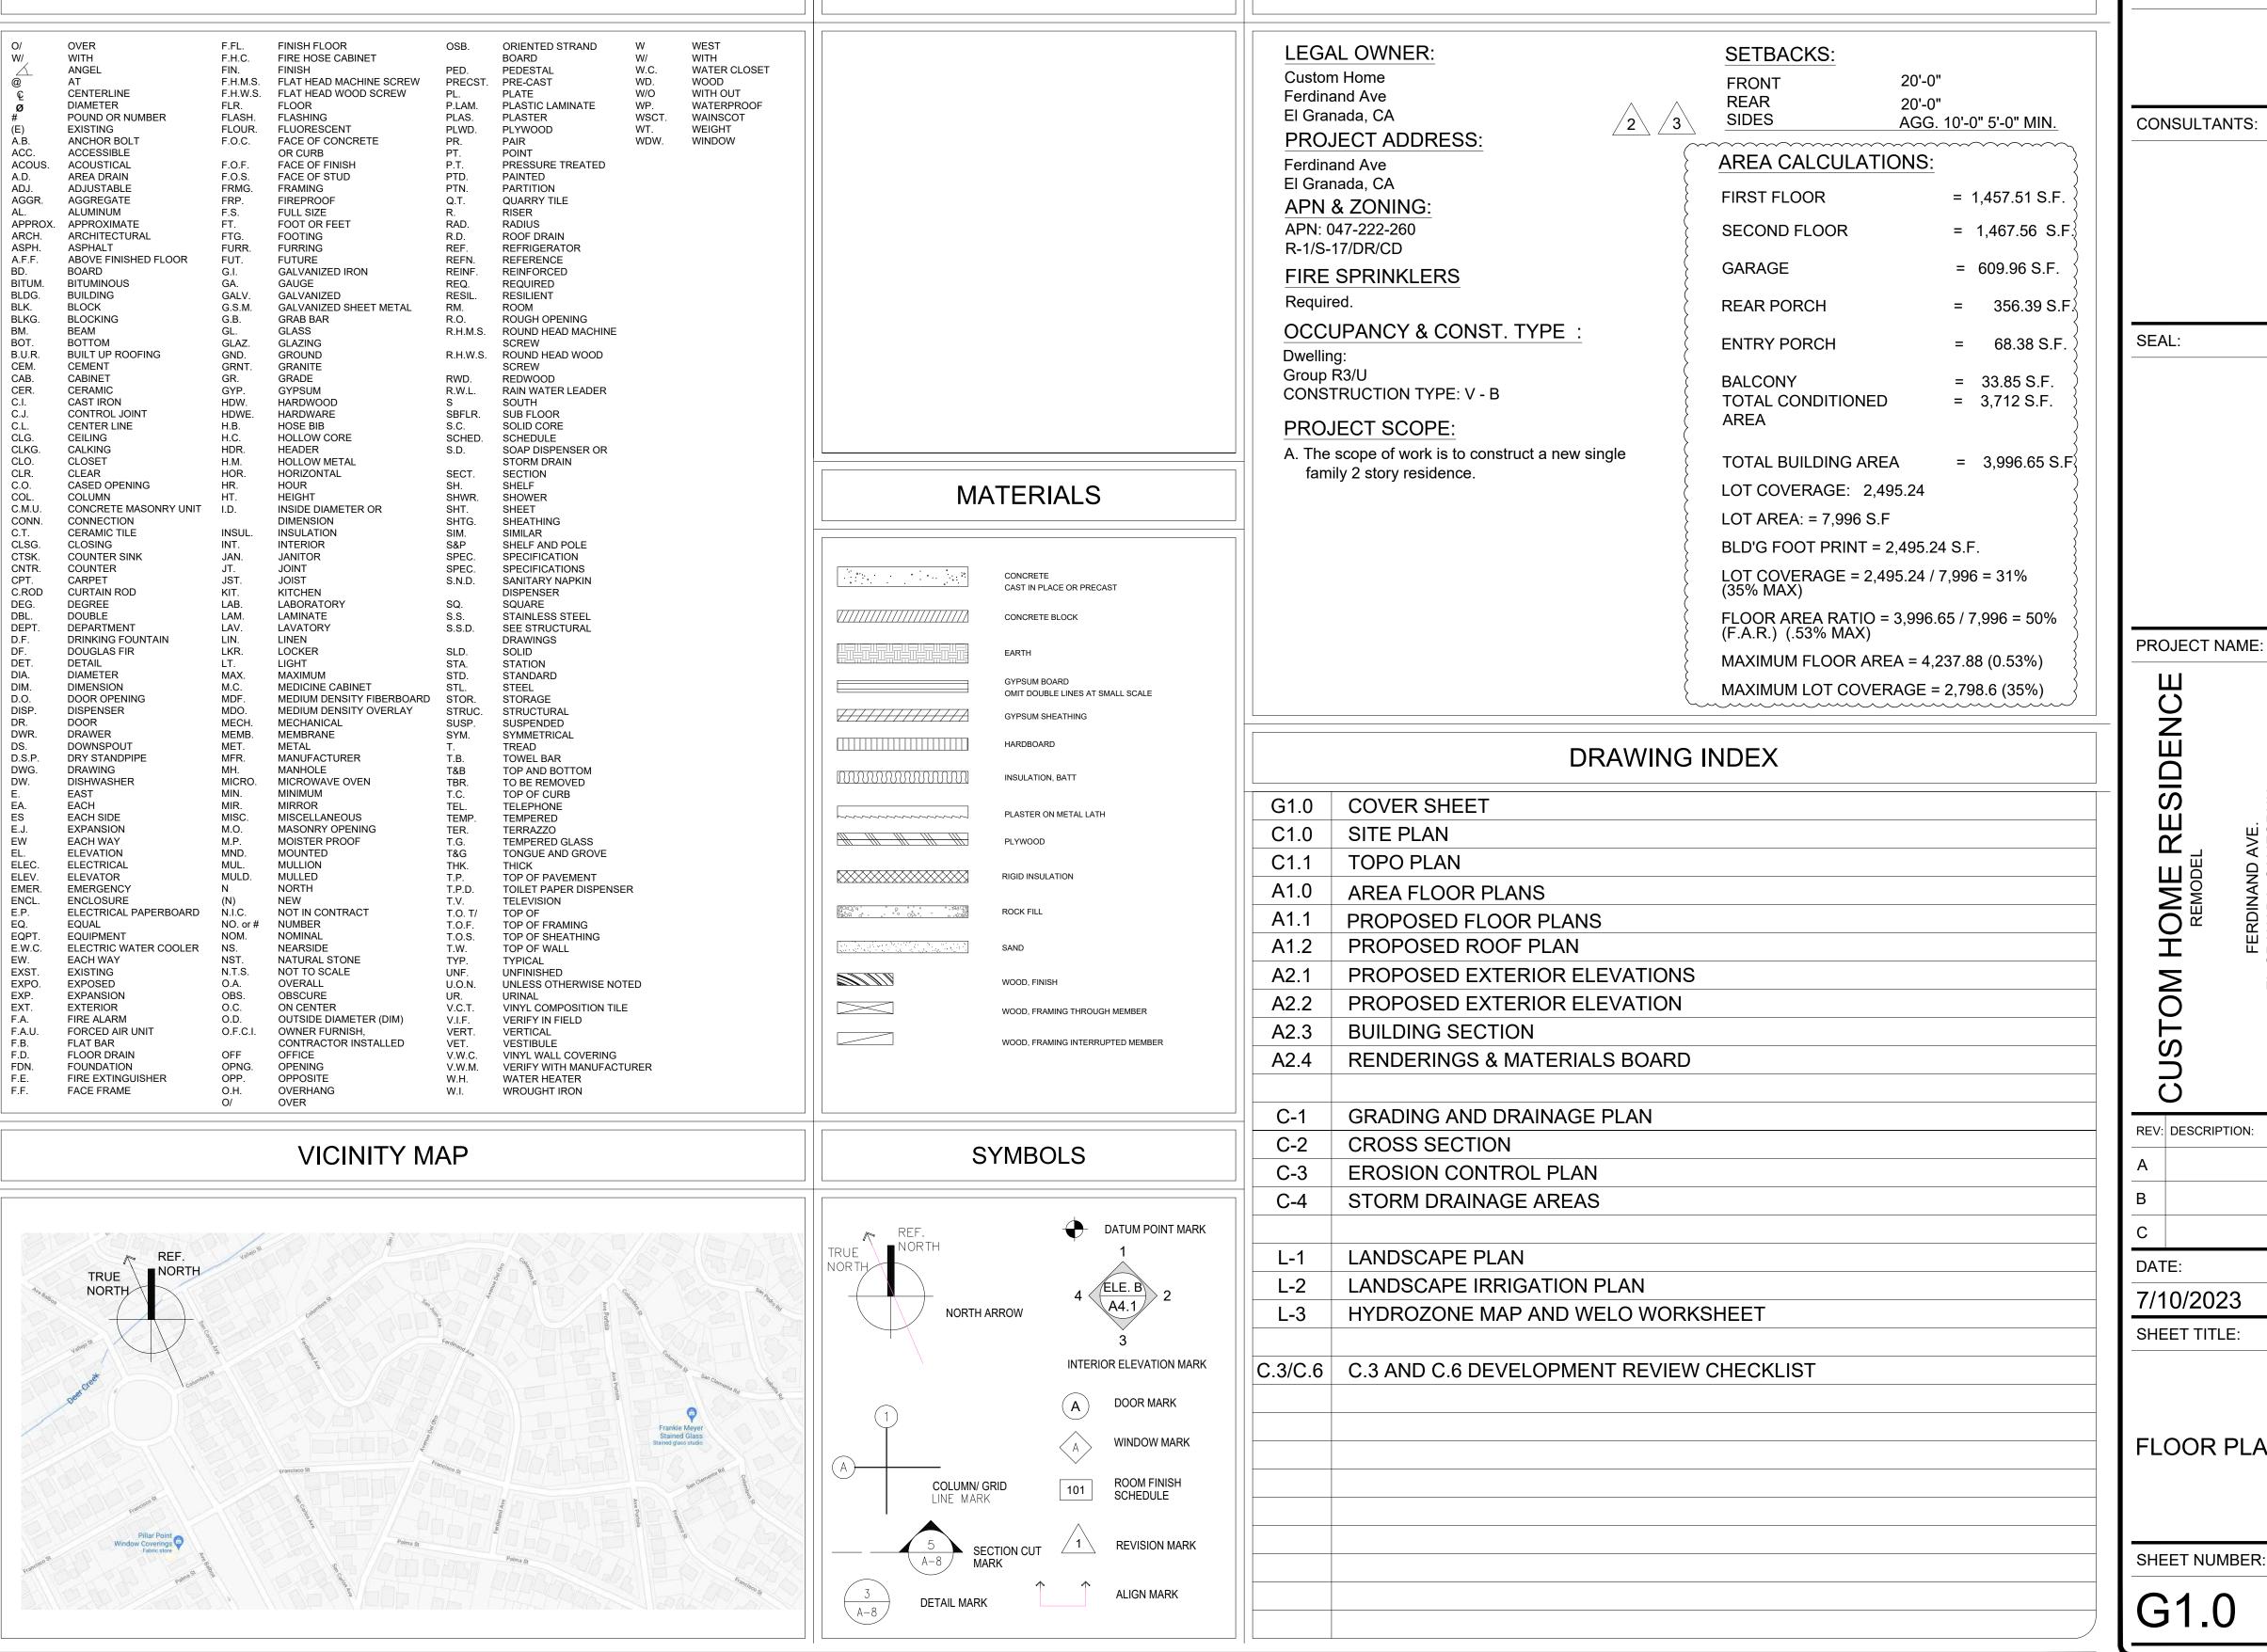

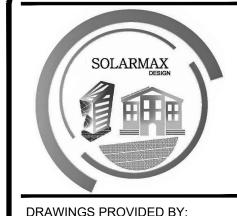

DRAWINGS PROVIDED BY **SOLAR MAX DESIGN** solarmax.dsgn@gmail.com www.solarmaxdsgn.com TEL: (310) 740-9649



Signature OWNER:

BUILDING DATA

CONSULTANTS:

PROJECT NAME: \circ

R.

OM HOME

REV: DESCRIPTION:

DATE:

7/10/2023

SHEET TITLE:

FLOOR PLANS

G1.0

SITE PLAN NOTES: — MAX. 28'-0" BLD. HT. 1. RAIN LEADERS ON THE DWELLING SHALL DRAIN TO LANDSCAPING AND TREATED TO THE MAXIMUM EXTENT PRACTICABLE. 2. A MINIMUM SLOPE OF 5% FOR A DISTANCE OF TEN FEET (MINIMUM) FROM THE BUILDING PAD IS REQUIRED FOR DRAINAGE. BEYOND THE 10' ENVELOPE AROUND THE BUILDING, SWALES AND ASPHALT CONCRETE PAVEMENT AREAS MUST DRAIN AT A MINIMUM SLOPE OF 1% 3. SURFACE DRAINAGE MUST BE FILTERED: RUNOFF FROM IMPERVIOUS SURFACES SHALL BE TREATED BY LANDSCAPING TO THE MAXIMUM EXTENT PRACTICABLE. 4. DUST SHALL BE CONTROLLED AT ALL TIMES. WASTEWATER GENERATED DURING CONSTRUCTION SHALL NOT BE DISCHARGED TO THE STORM DRAIN SYSTEM. THIS INCLUDES WASTE FROM PAINTING, SAW CUTTING, CONCRETE WORK, ETC. THE CONTRACTOR SHALL MAKE ALL NECESSARY ARRANGEMENTS TO ELIMINATE DISCHARGES TO THE STORM DRAIN SYSTEM, AND PROVIDE AN AREA FOR ON-SITE WASHING ACTIVITIES DURING CONSTRUCTION. MATERIALS THAT COULD CONTAMINATE STORM RUNOFF SHALL BE STORED IN THE AREAS THAT ARE DESIGNED TO PREVENT EXPOSURE TO RAINFALL AND TO NOT ALLOW STORM WATER TO RUN ONTO THE AREA. — NATURAL GRADE ______ - - + - - - + - - + - - -______ . — + — — — + — — + — |-______ ______ ______ CRAWL SPACE _____ ______ ______ ______ SITE SECTION SCALE: 1/8" = 1'-0" ±5' WRE FENCE 21'-10" (TAKEN FROM REAR PORCH TO PL. 5'-0" MIN. SIDEYARD SETBACK APN 047-222-36 PROPOSED TWO STORY RESIDENCE (HATCHED) 20'-0" MIN. FRONT_ YARD SETBACK M 20'-0" MIN. REAR (N) CONC. DRIVE WAY YARD SETBACK RDINAND – 14"Ø TREE TO BE REMOVED 24"Ø TREE TO BE REMOVED GUY WIF STAMPED CONC. AVENU PROVIDE 42" – HIGH GUARD RAILING 10'-0" MIN. SIDE YARD SETBACK (40' TRUE NORTH REFERENCE NORTH DRIVEWAY SCALE: 1/8" = 1'-0" SITE PLAN SCALE: 1/8" = 1'-0"



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www.solarmaxdsgn.com
TEL: (310) 740-9649
(310) 844-7370



OWNER:

CONSULTANTS:

SEAL:

PROJECT NAME:

OM HOME RESIDENCE
REMODEL
FERDINAND AVE.
EL GRANADA, CALIFORNIA
APN: 047-222-260

REV: DESCRIPTION: DATE:

A
B

DATE:


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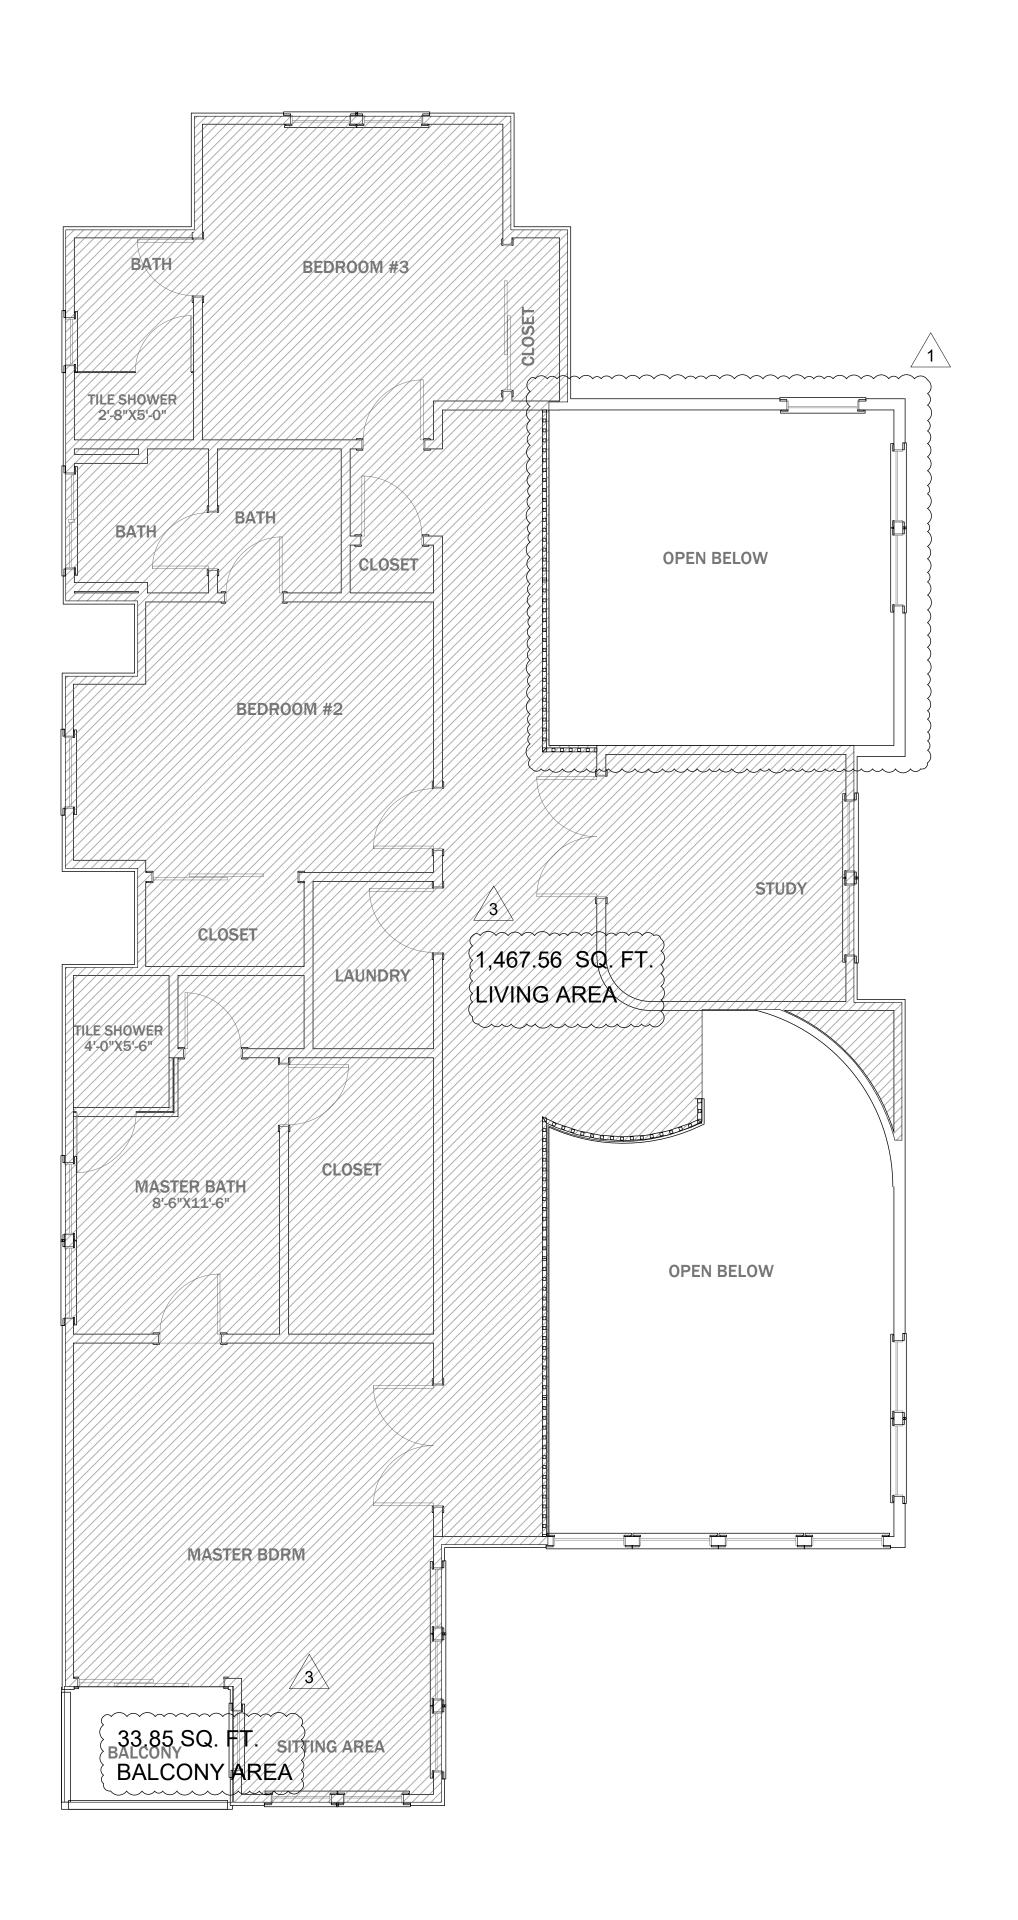
FLOOR PLANS


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THE CONSTRUCTION SHALL NOT RESTRICT A FIVE-FOOT CLEAR AND UNOBSTRUCTED ACCESS TO ANY WATER OR POWER DISTRIBUTION FACILITIES (POER POLES, PULL-BOXES, TRANSFORMERS, VAULTS, PUMPS, VALVES, METERS, APPURTENANCES, ETC.) OR TO THE LOCATION OF THE HOOK-UP. THE CONSTRUCTION SHALL NOT BE WITHIN THE FEET OR ANY POWER LINES-WHETHER OR NOT THE LINES ARE LOCATED ON THE PROPERTY. FAILURE TO COMPLY MAY CAUSE CONSTRUCTION DELAYS AND/OR ADDITIONAL EXPENSES.


AN APPROVED SEISMIC GAS SHUT OFF VALVE OR EXCESS FLOW SHUT OFF VALVE WILL BE INSTALLED ON THE FUEL GAS LINE ON THE DOWN-STREAM SIDE OF THE UTILITY METER AND BE RIGIDLY CONNECTED TO THE EXTERIOR OF THE BUILDING OR STRUCTURE CONTAINING THE FUEL PIPING. (PER ORDINANCE 170,158 AND 180, 670) SEPARATE PLUMBING PERMIT IS REQUIRED.

PROVIDE ULTRA-FLUSH WATER CLOSETS FOR ALL NEW CONSTRUCTION. EXISTING SHOWER HEADS AND TOILETS MUST BE ADAPTED FOR LOW WATER CONSUMPTION.

PROVIDE (72) INCH HIGH NON-ABSORBENT WALL ADJACENT TO SHOWER AND APPROVED SHATTER-RESISTANT MATERIALS FOR SHOWER ENCLOSURE. (1210.2.3, 2406.4.5, R307.2, R308.4)

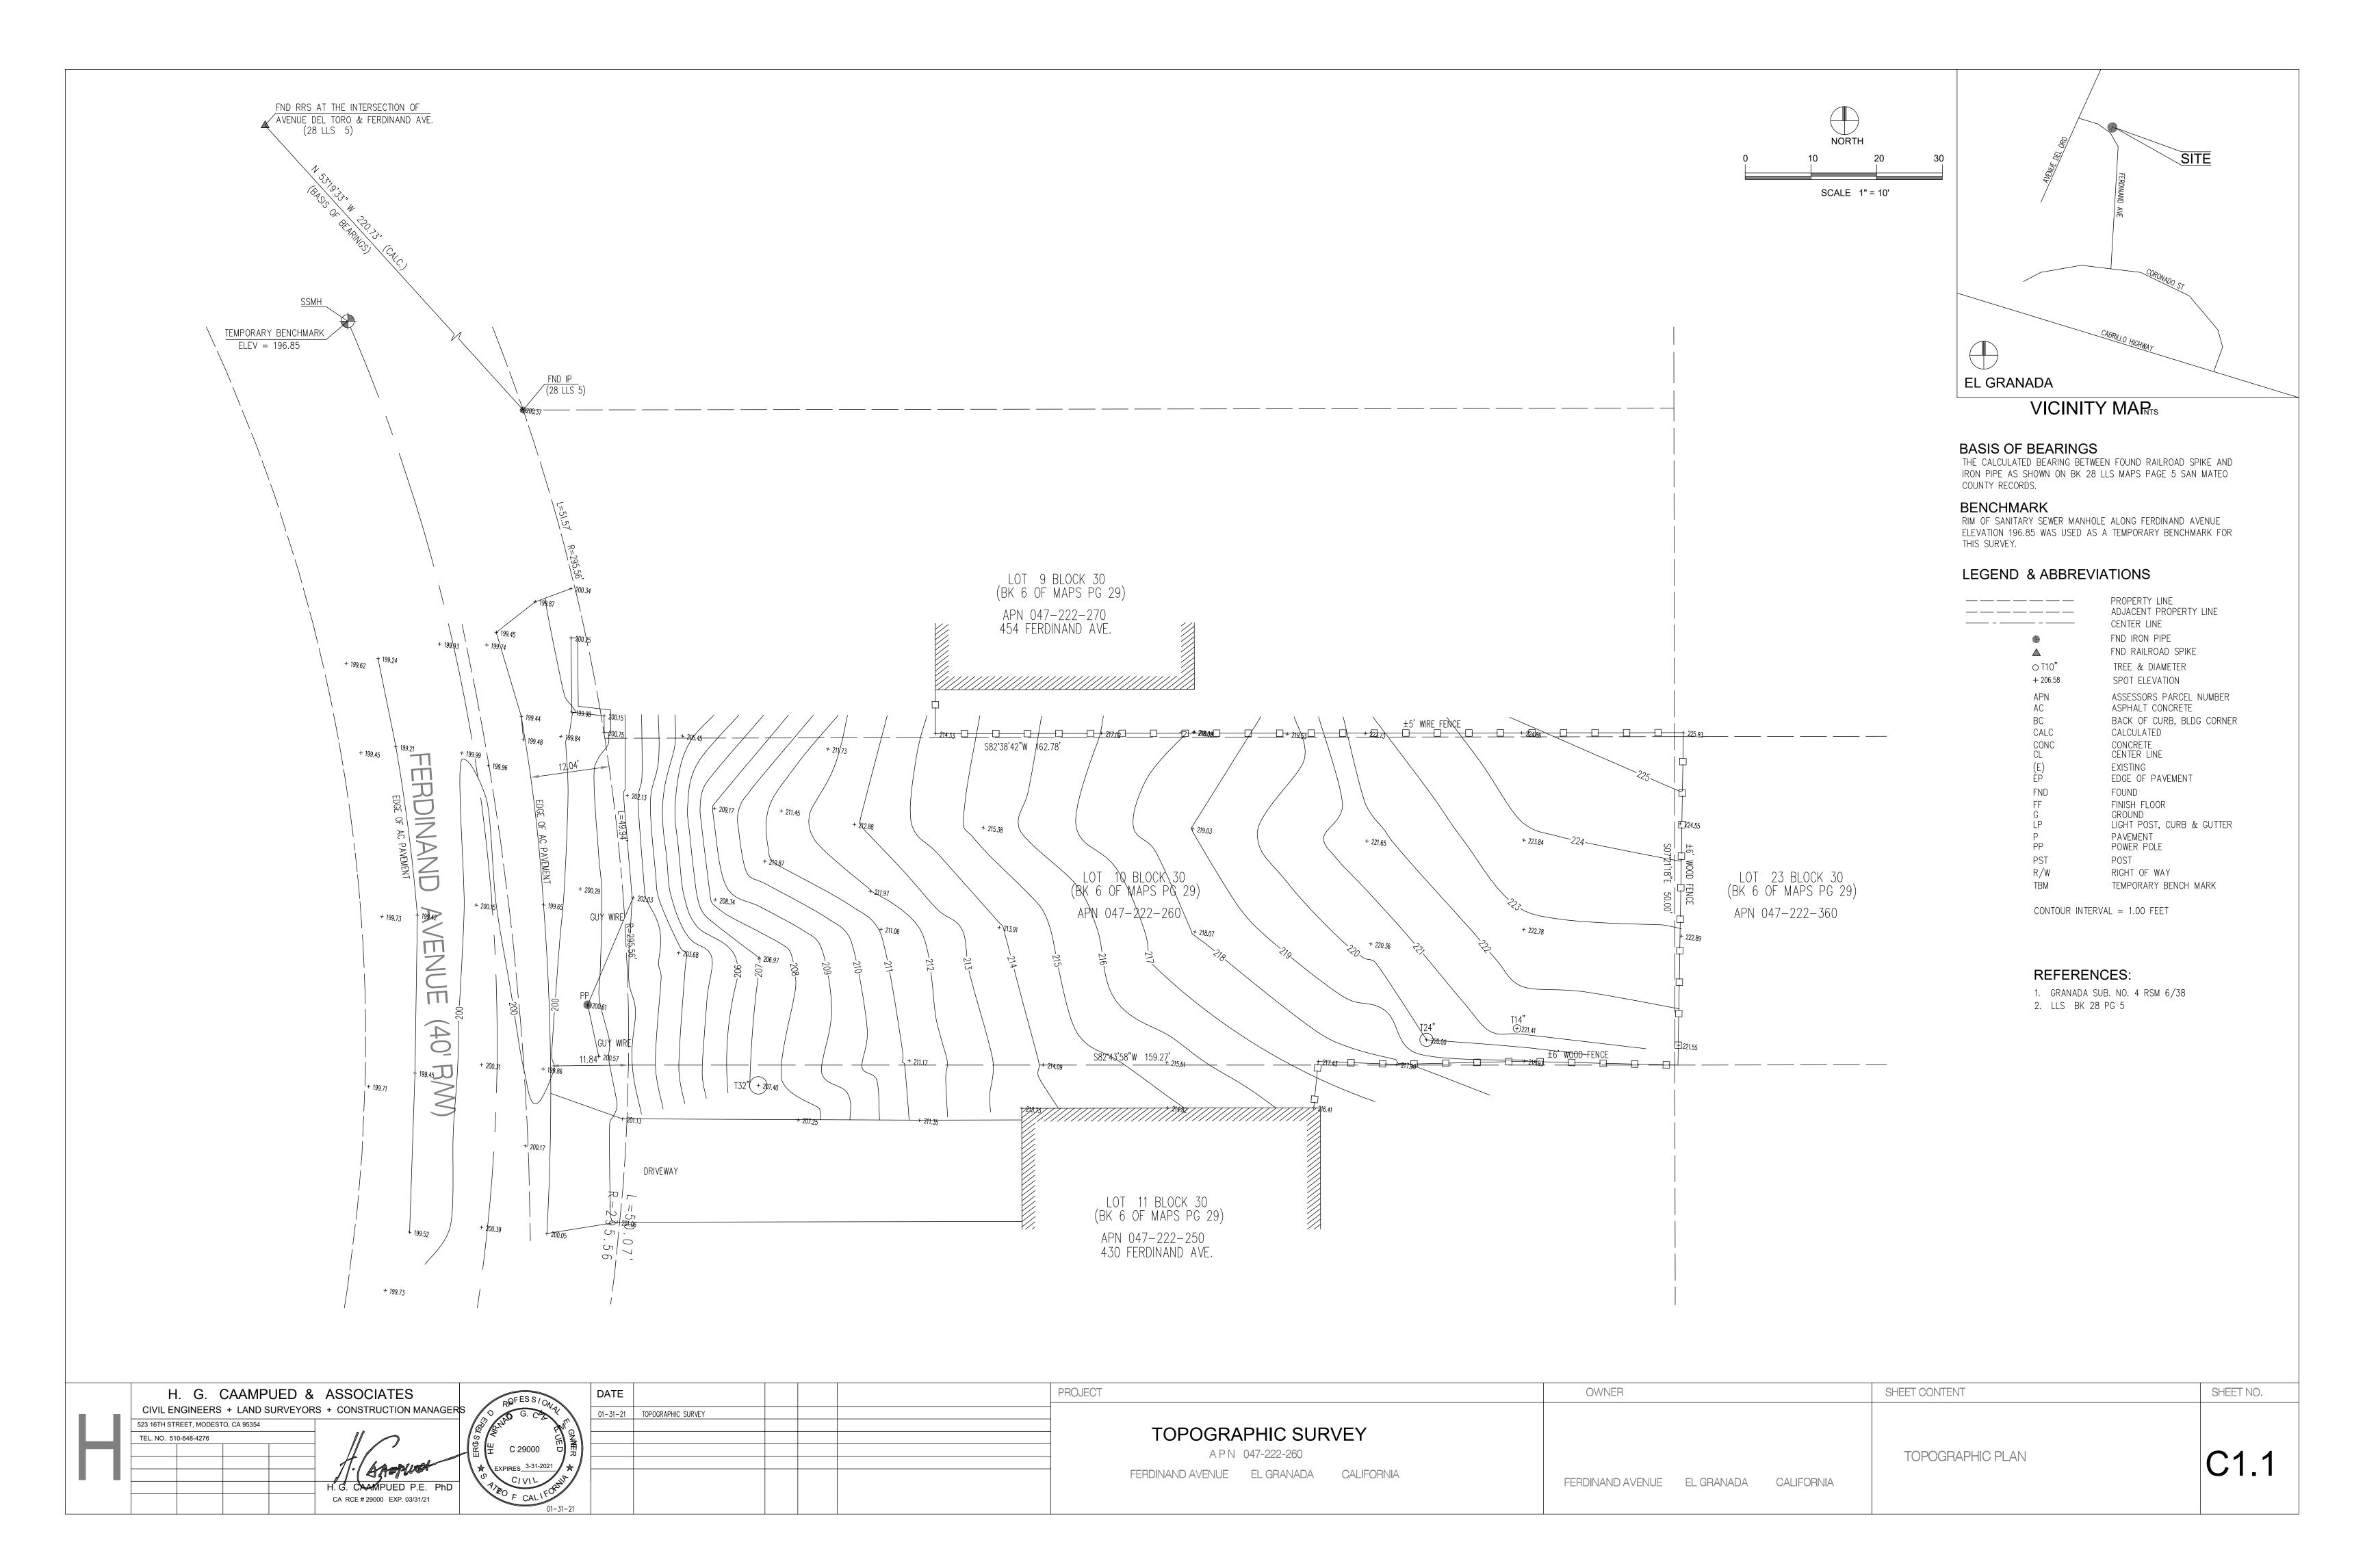WATER HEATER MUST BE STRAPPED TO WALL, (507.3 & LAPC)

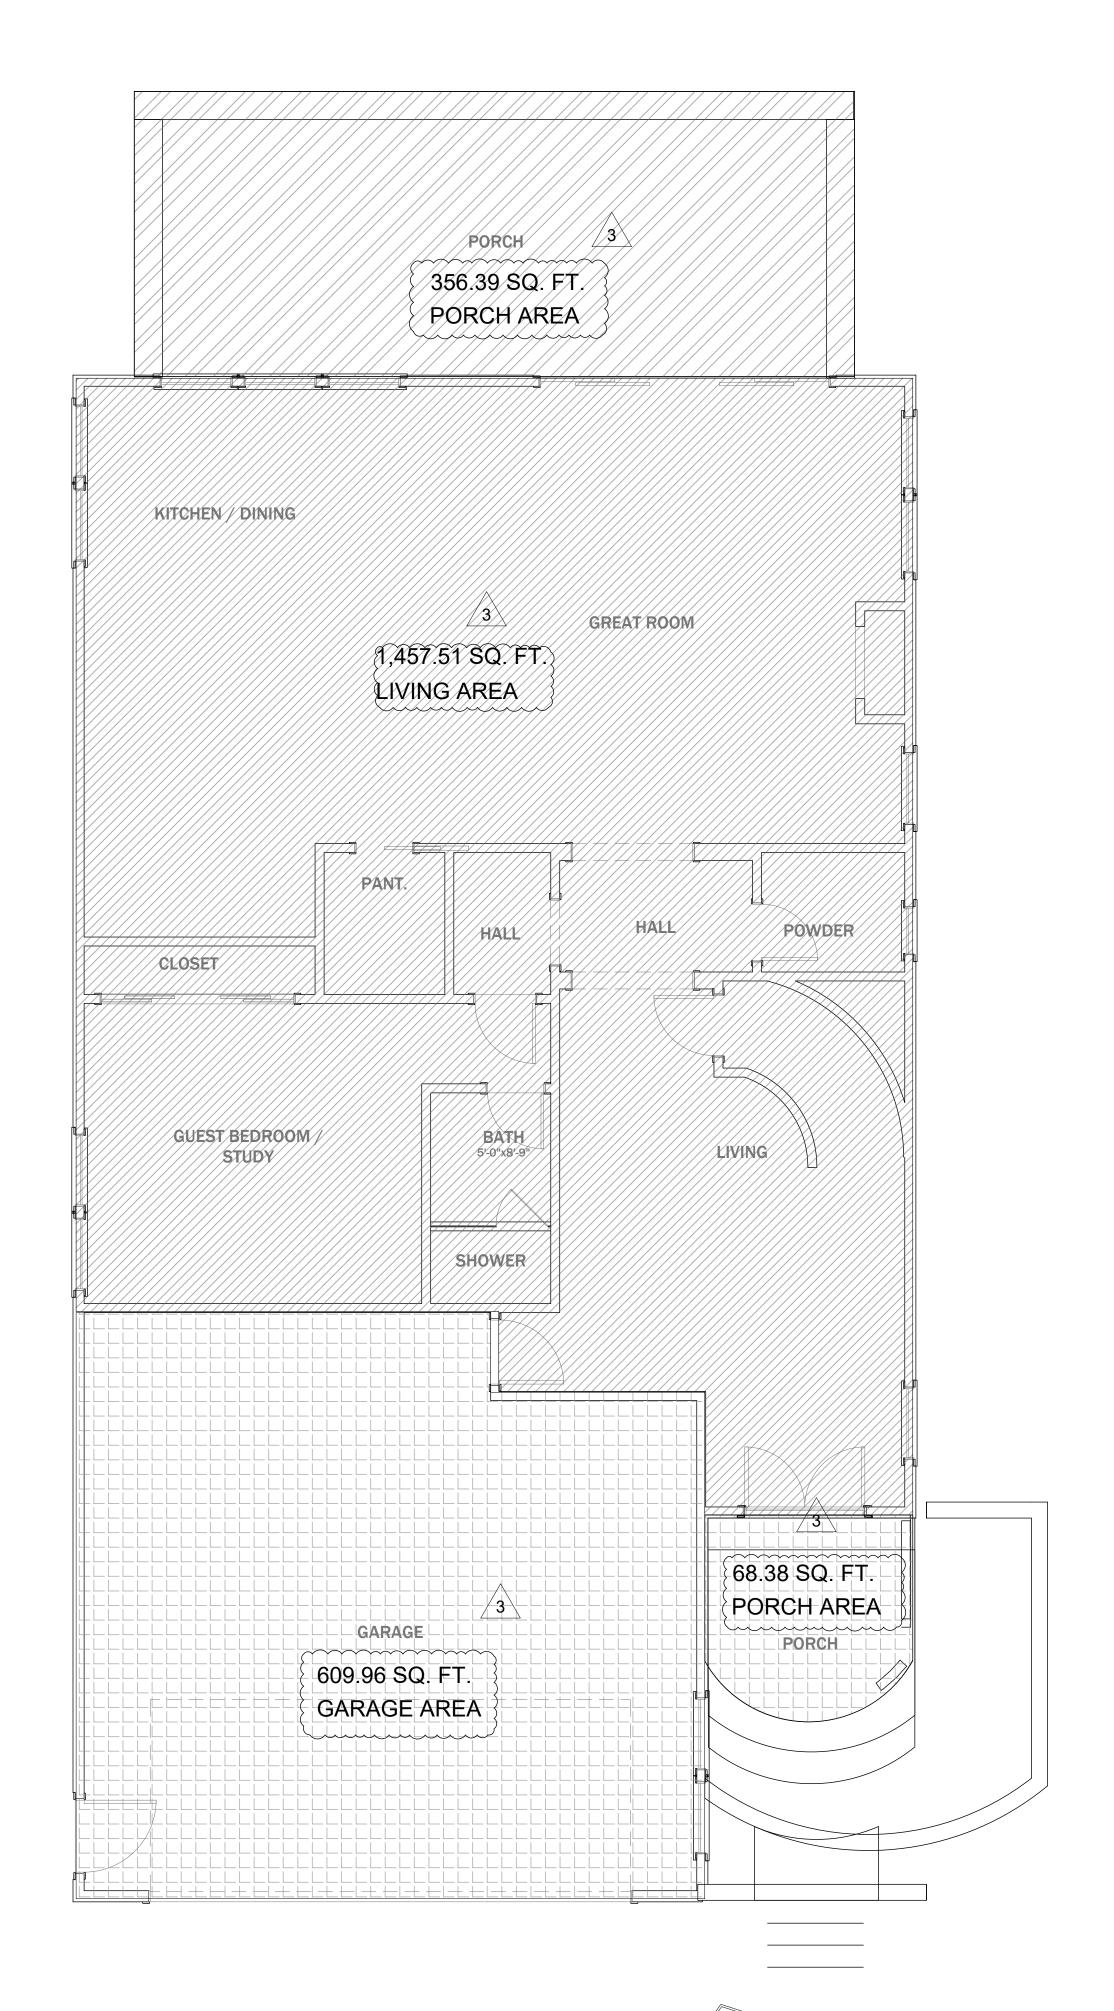2 3 AREA CALCULATIONS: FIRST FLOOR = 1,457.51 S.F. = 1,467.56 S.F. SECOND FLOOR GARAGE = 609.96 S.F. = 356.39 S.F. **REAR PORCH** = 68.38 S.F. **ENTRY PORCH** = 33.85 S.F. BALCONY = 3,712 S.F. TOTAL CONDITIONED TOTAL BUILDING AREA = 3,996.65 S.F LOT COVERAGE: 2,495.24 LOT AREA: = 7,996 S.F BLD'G FOOT PRINT = 2,495.24 S.F. LOT COVERAGE = 2,495.24 / 7,996 = 31% (35% MAX) FLOOR AREA RATIO = 3,996.65 / 7,996 = 50% (F.A.R.) (.53% MAX) MAXIMUM FLOOR AREA = 4,237.88 (0.53%) MAXIMUM LOT COVERAGE = 2,798.6 (35%)

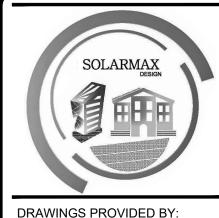

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Signature OWNER:

CONSULTANTS:

SEAL:

PROJECT NAME: OM HOME RESIDENCE

REV: DESCRIPTION:

DATE:


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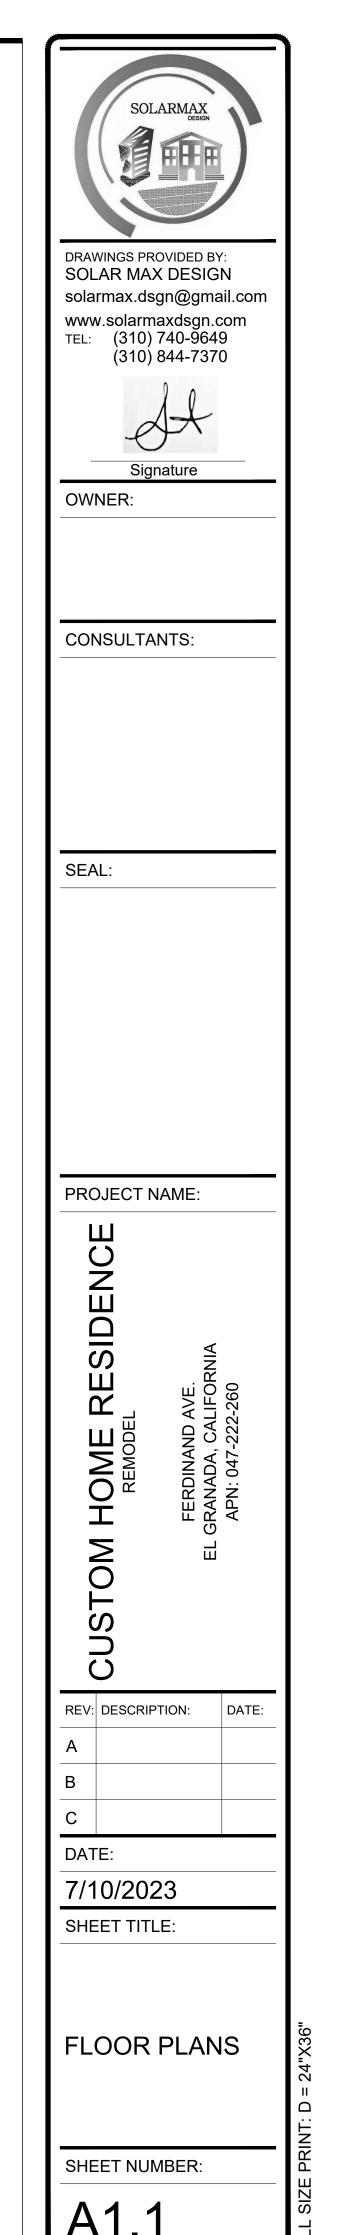
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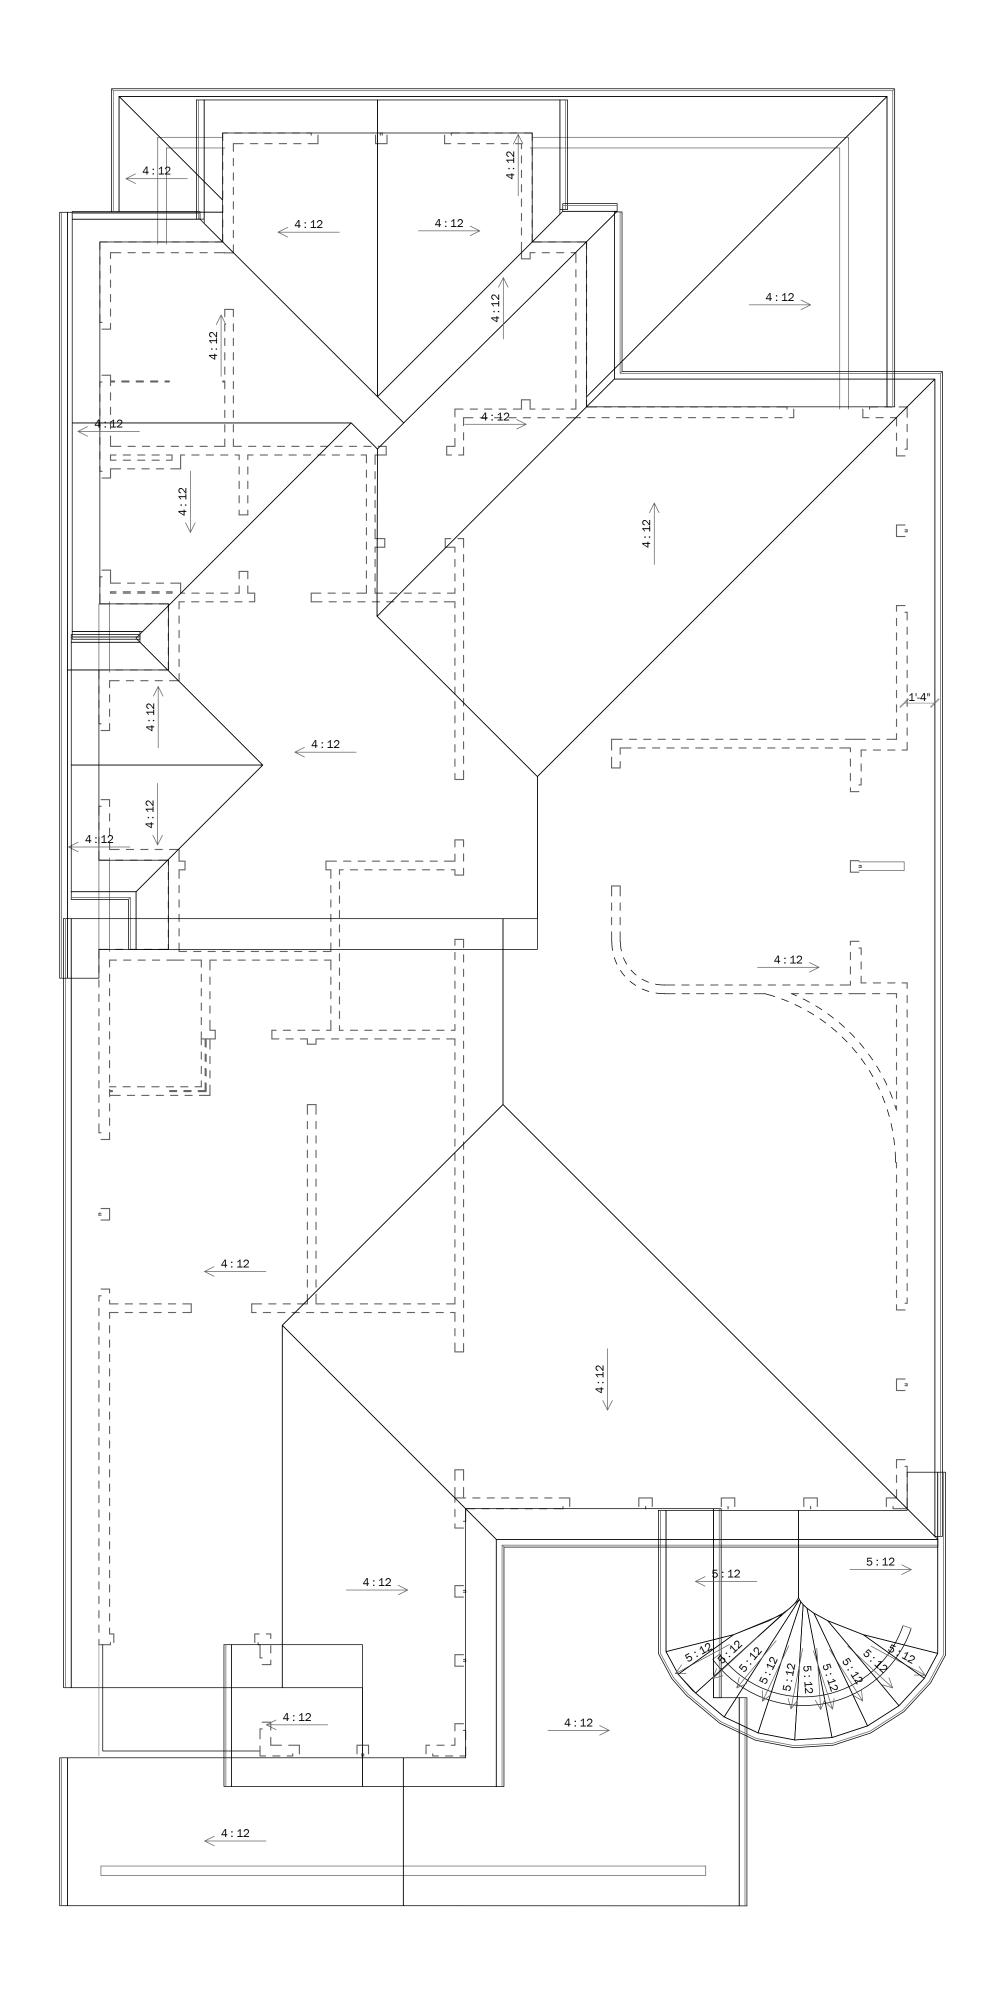
FLOOR PLANS


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FIRST FLOOR PLAN
SCALE: 1/4"-1'-0"








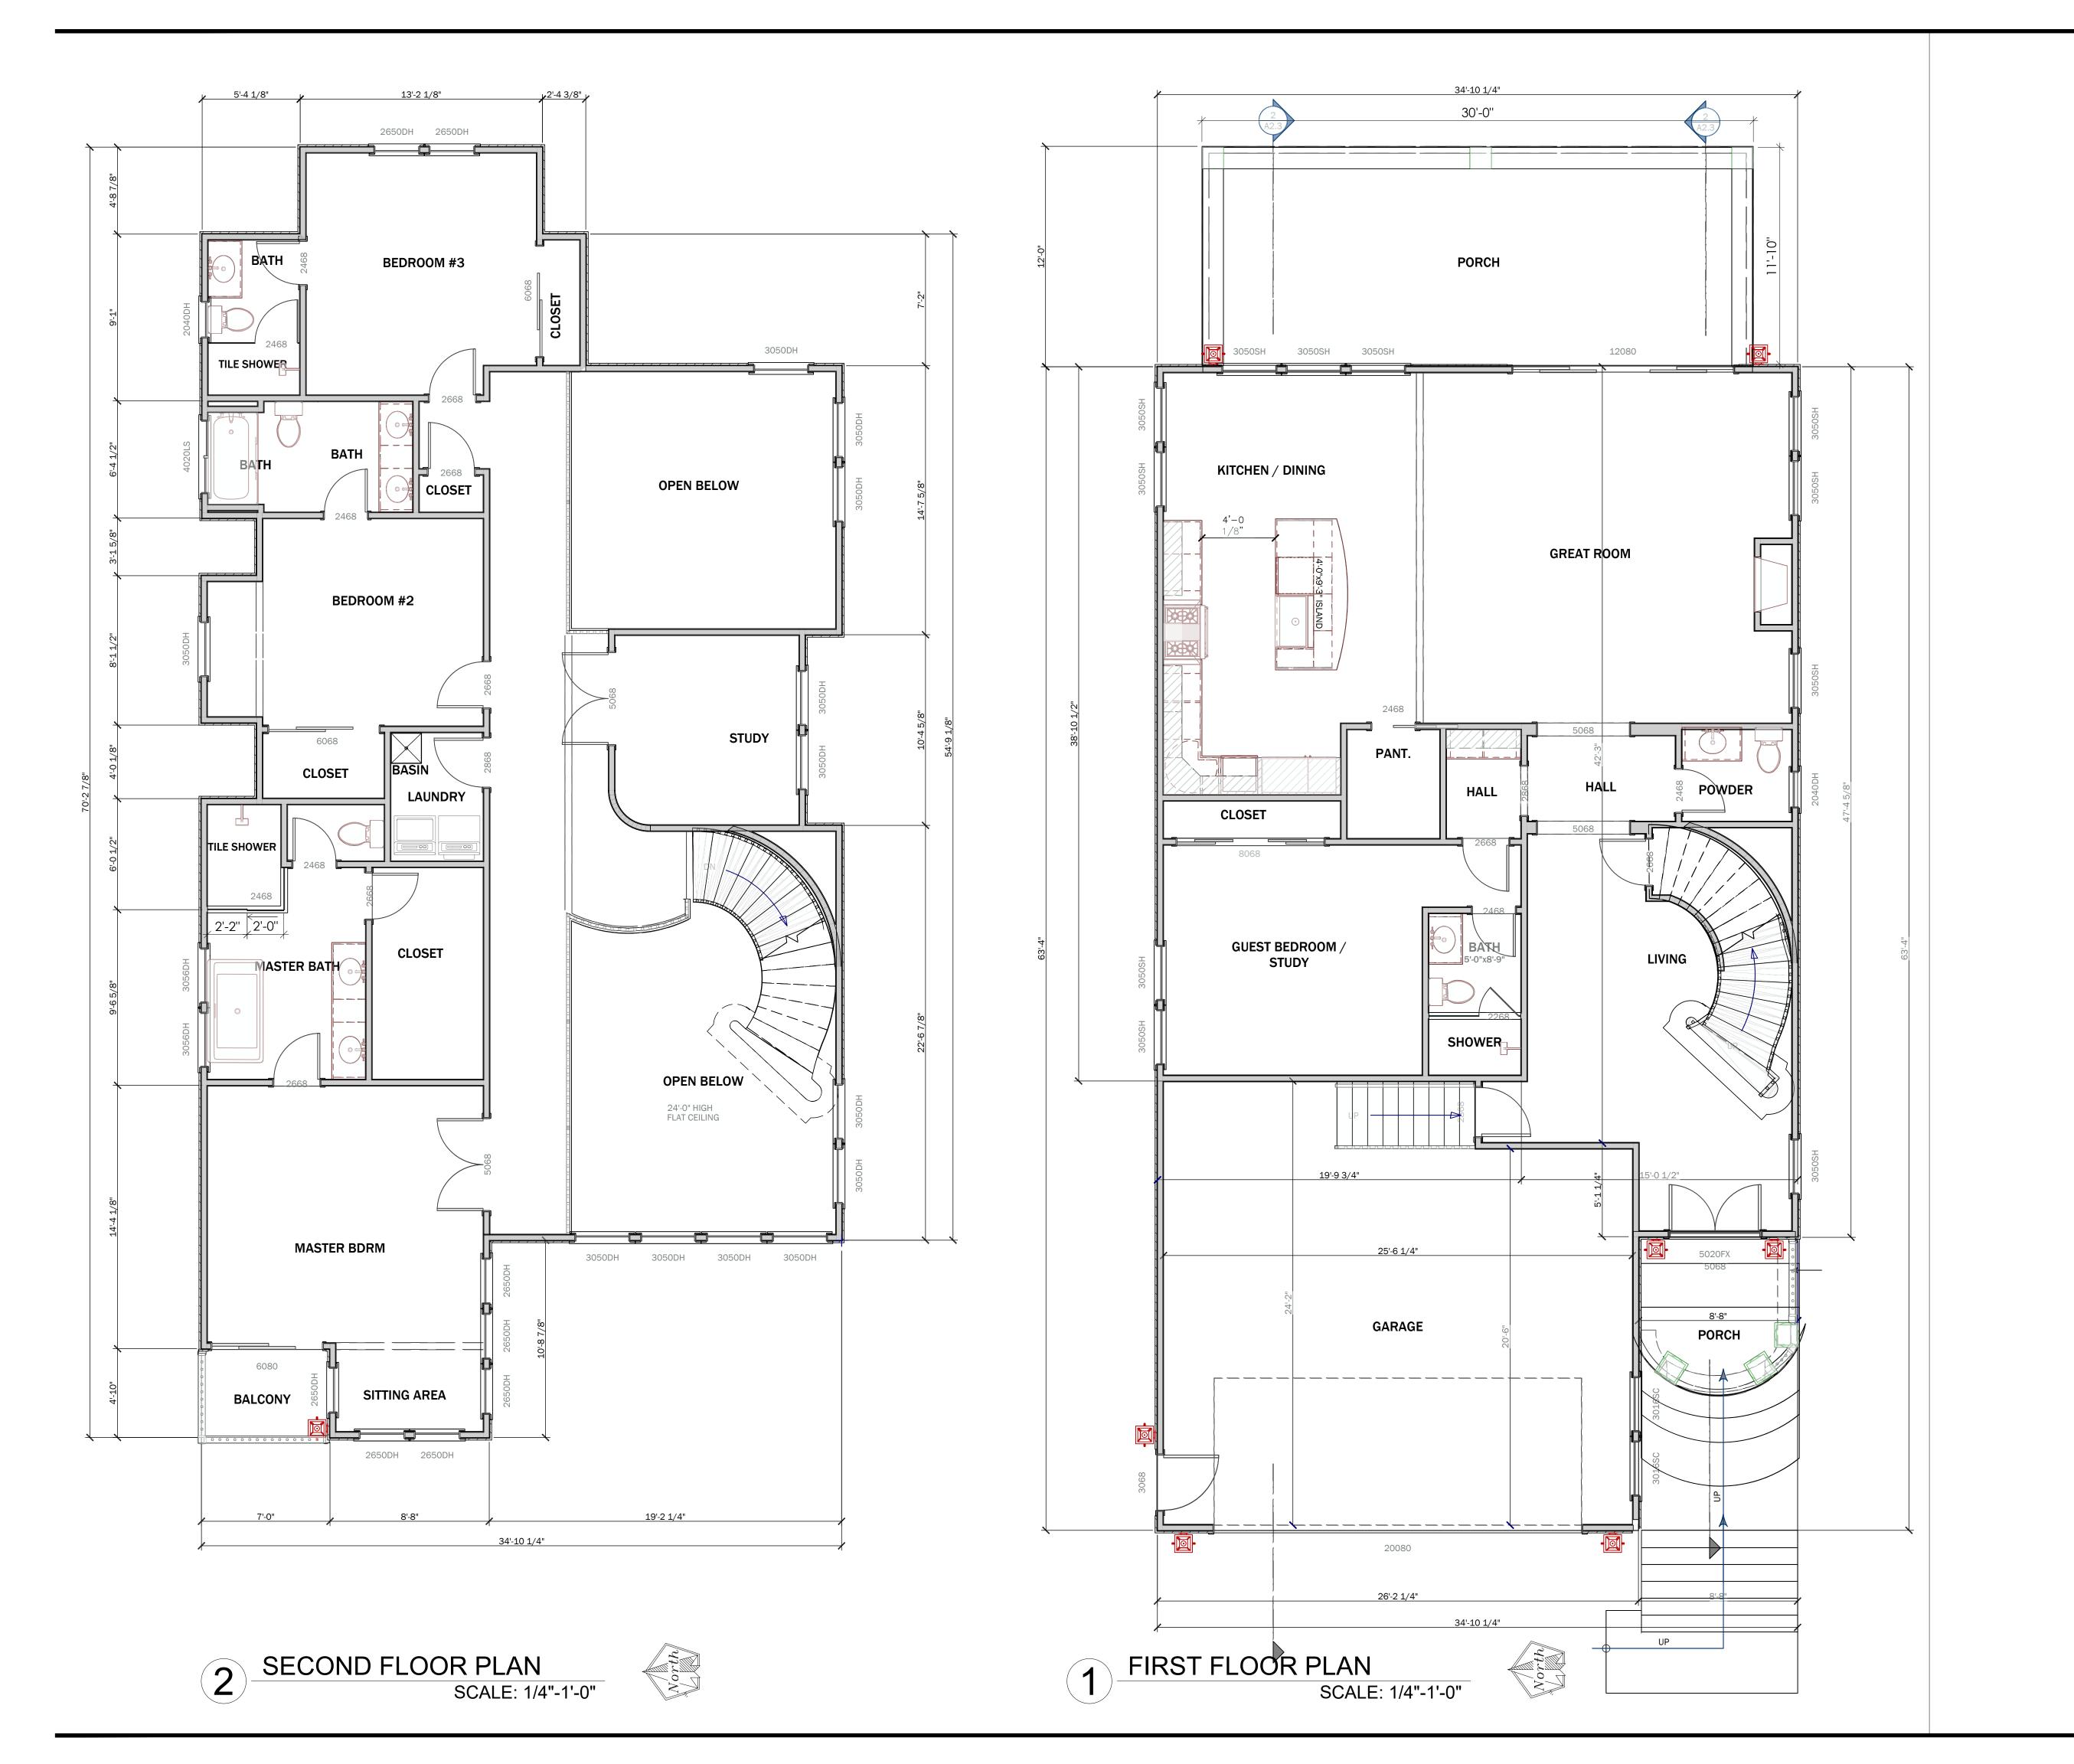


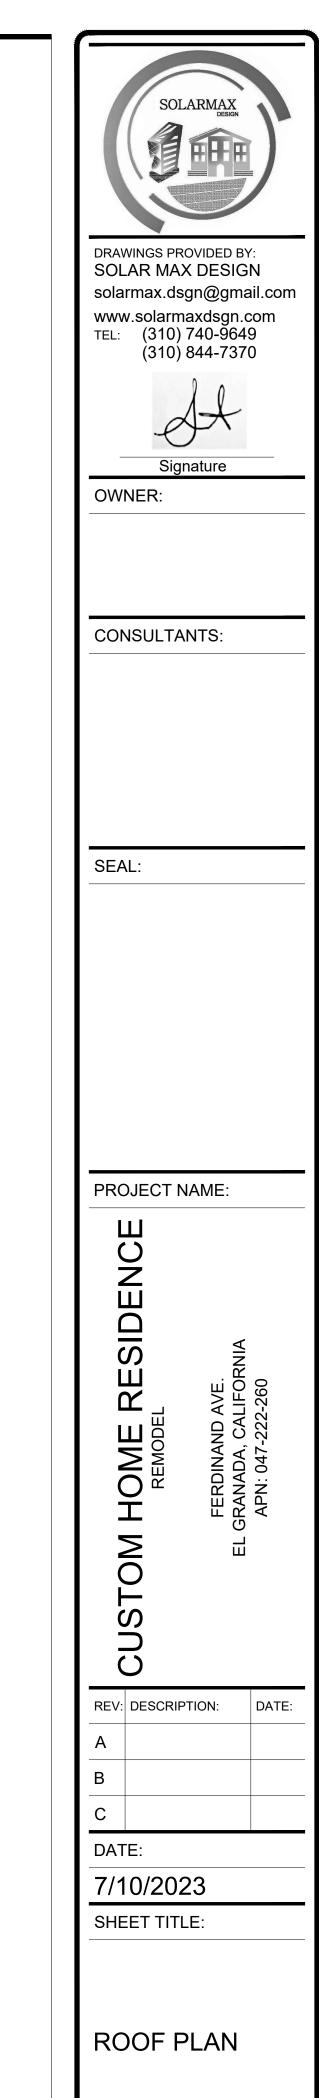SHEET NUMBER:

1 ROOF PLAN

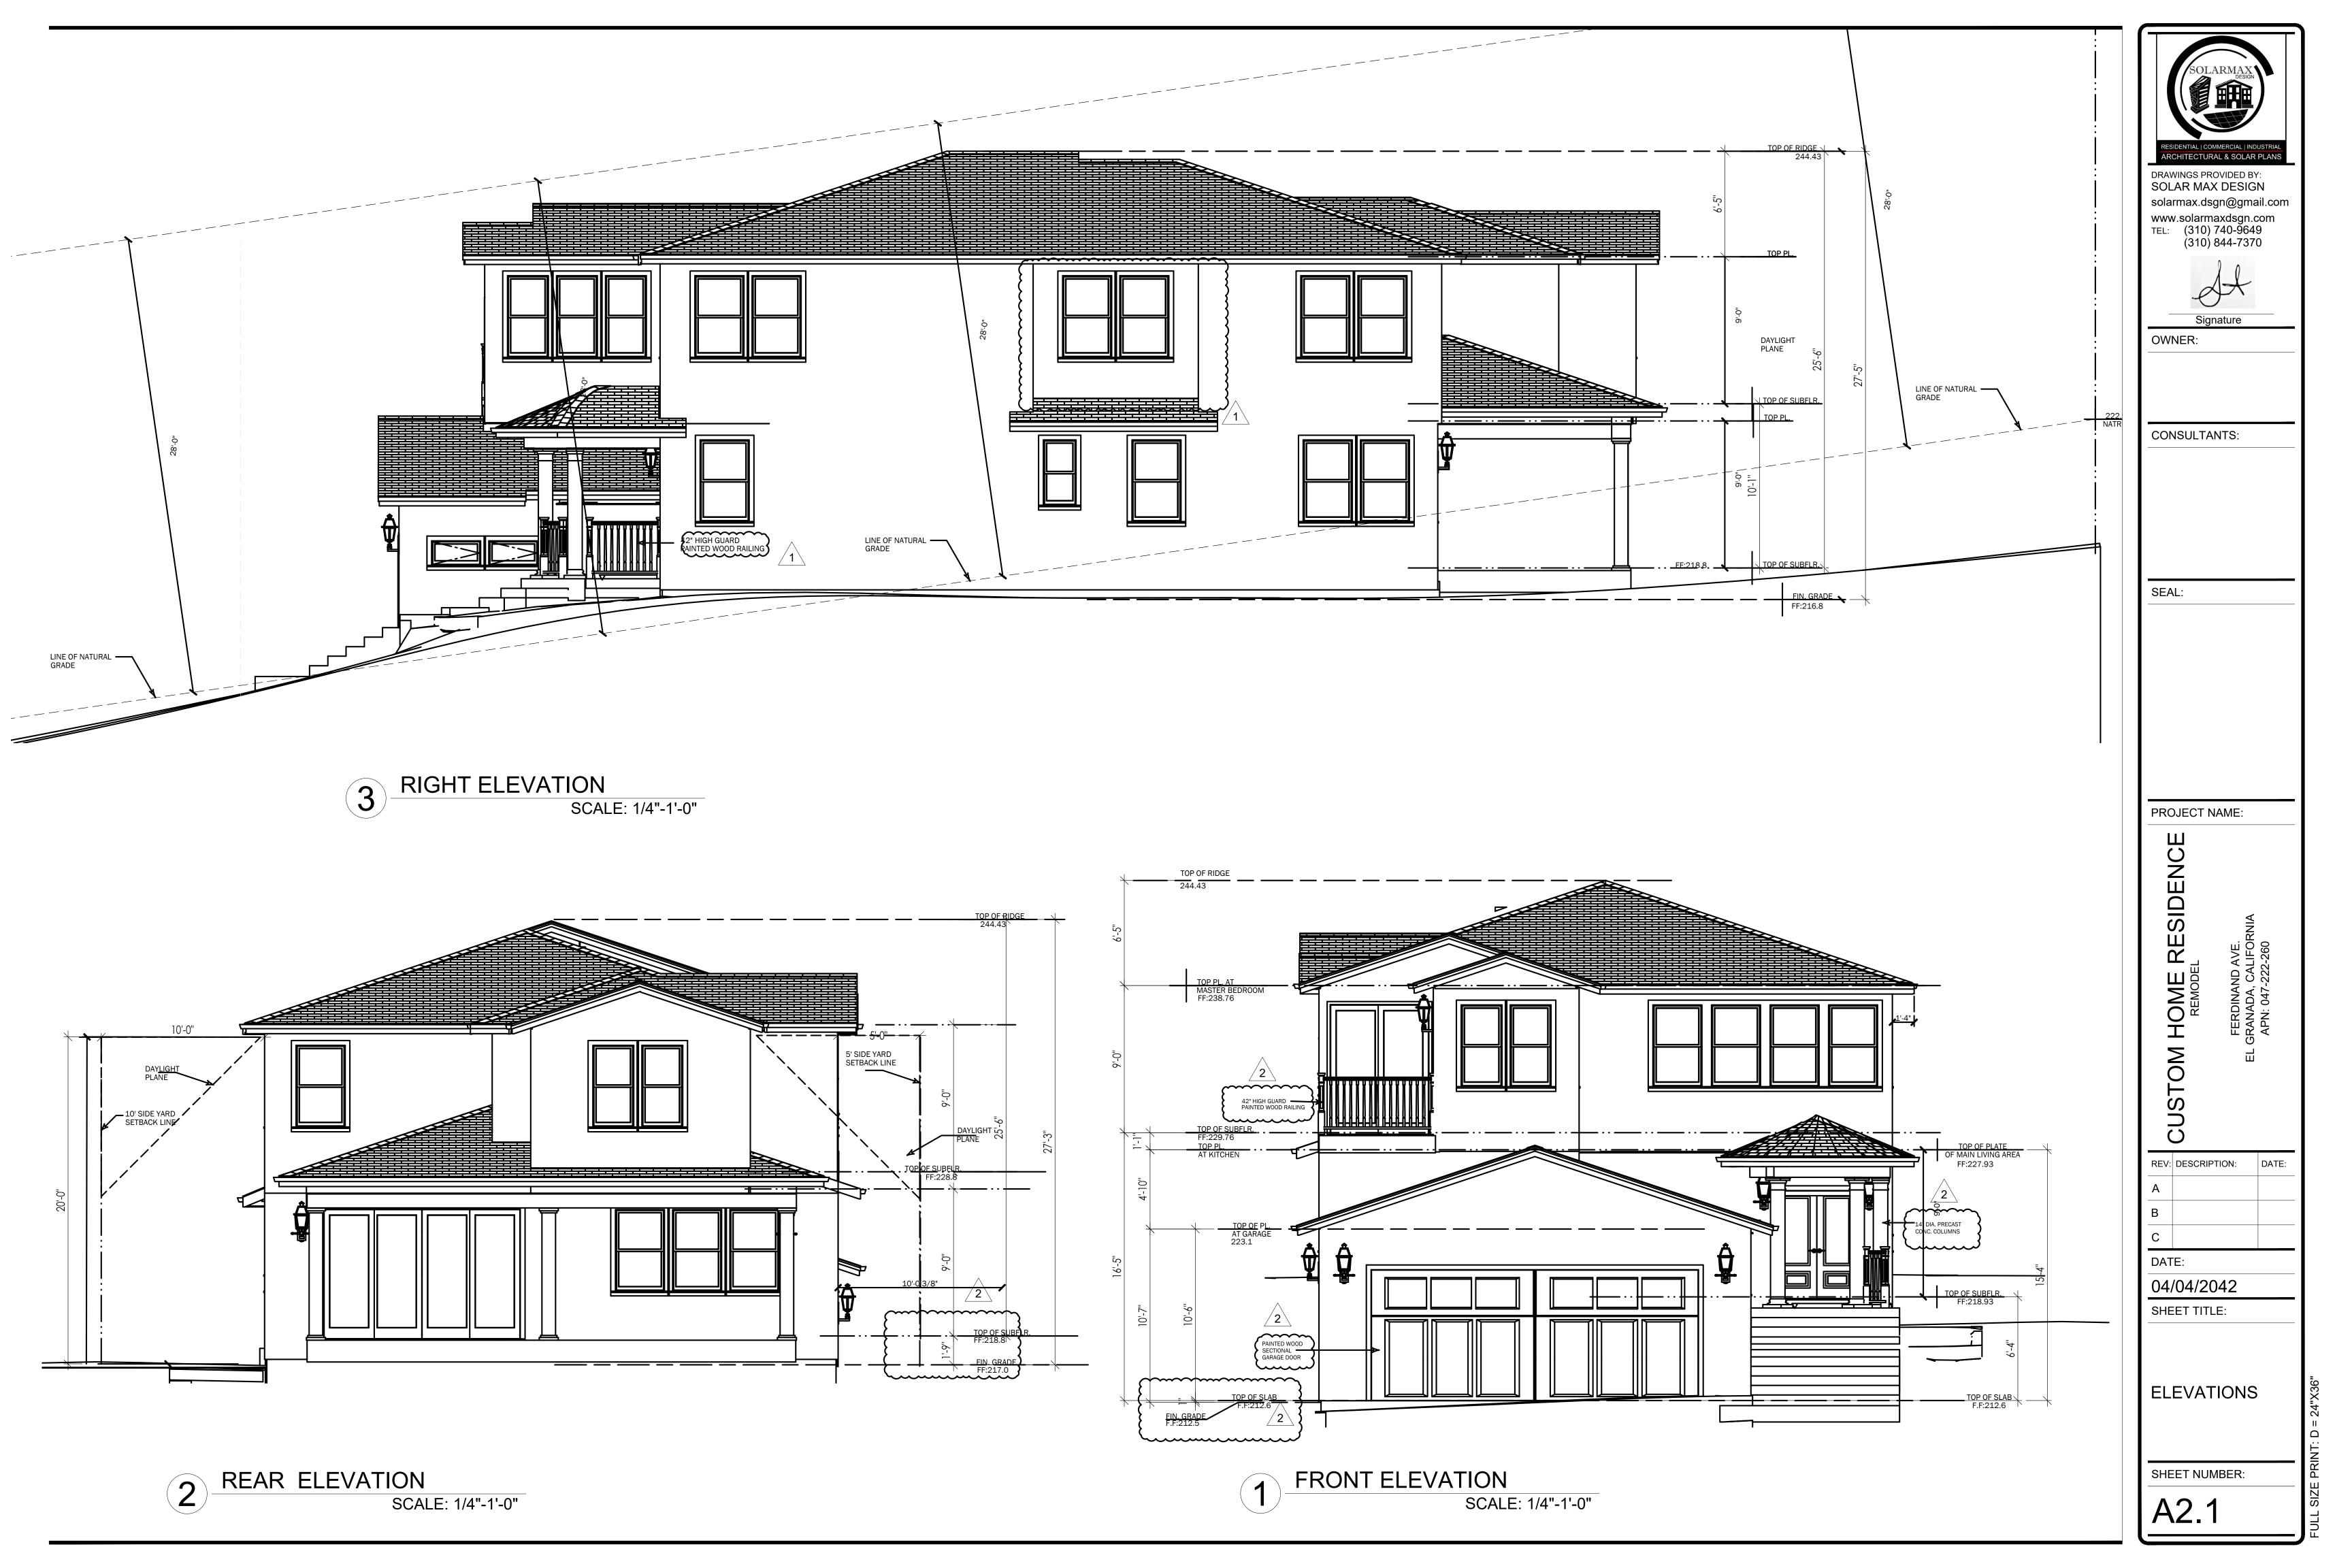



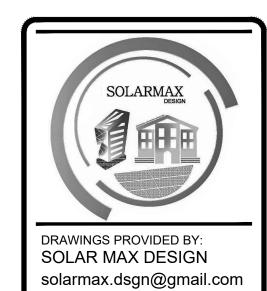

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Signature

OWNER:

CONSULTANTS:

SEAL:

PROJECT NAME:

CUSTOM HOME RESIDENCE

FERDINAND AVE.
EL GRANADA, CALIFORNIA

REV: DESCRIPTION: DATE:

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B
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DATE: 7/10/2023

SHEET TITLE:


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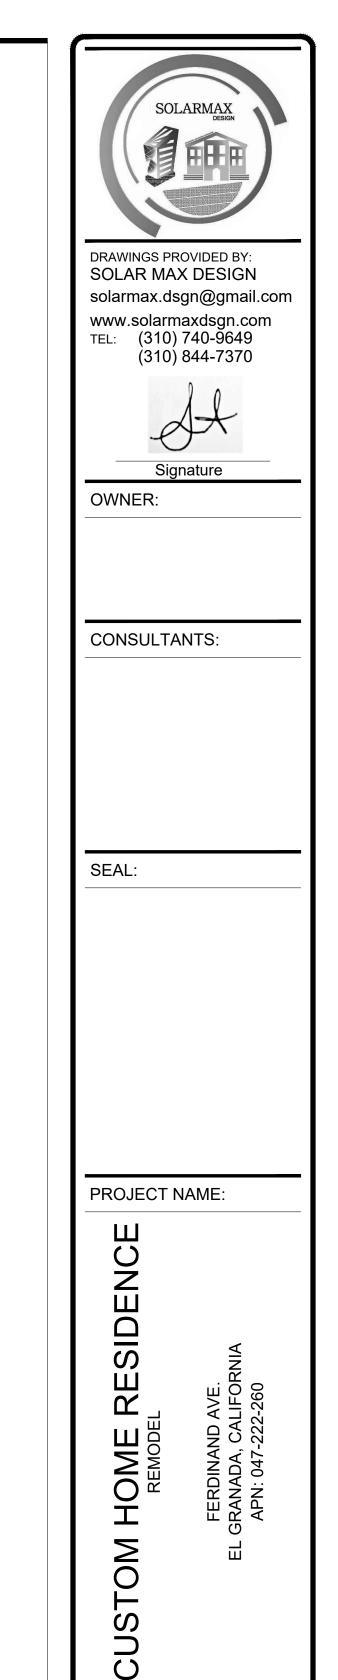
A2.2



LONGITUDINAL BUILDING SECTIONS SCALE: 1/4"-1'-0"





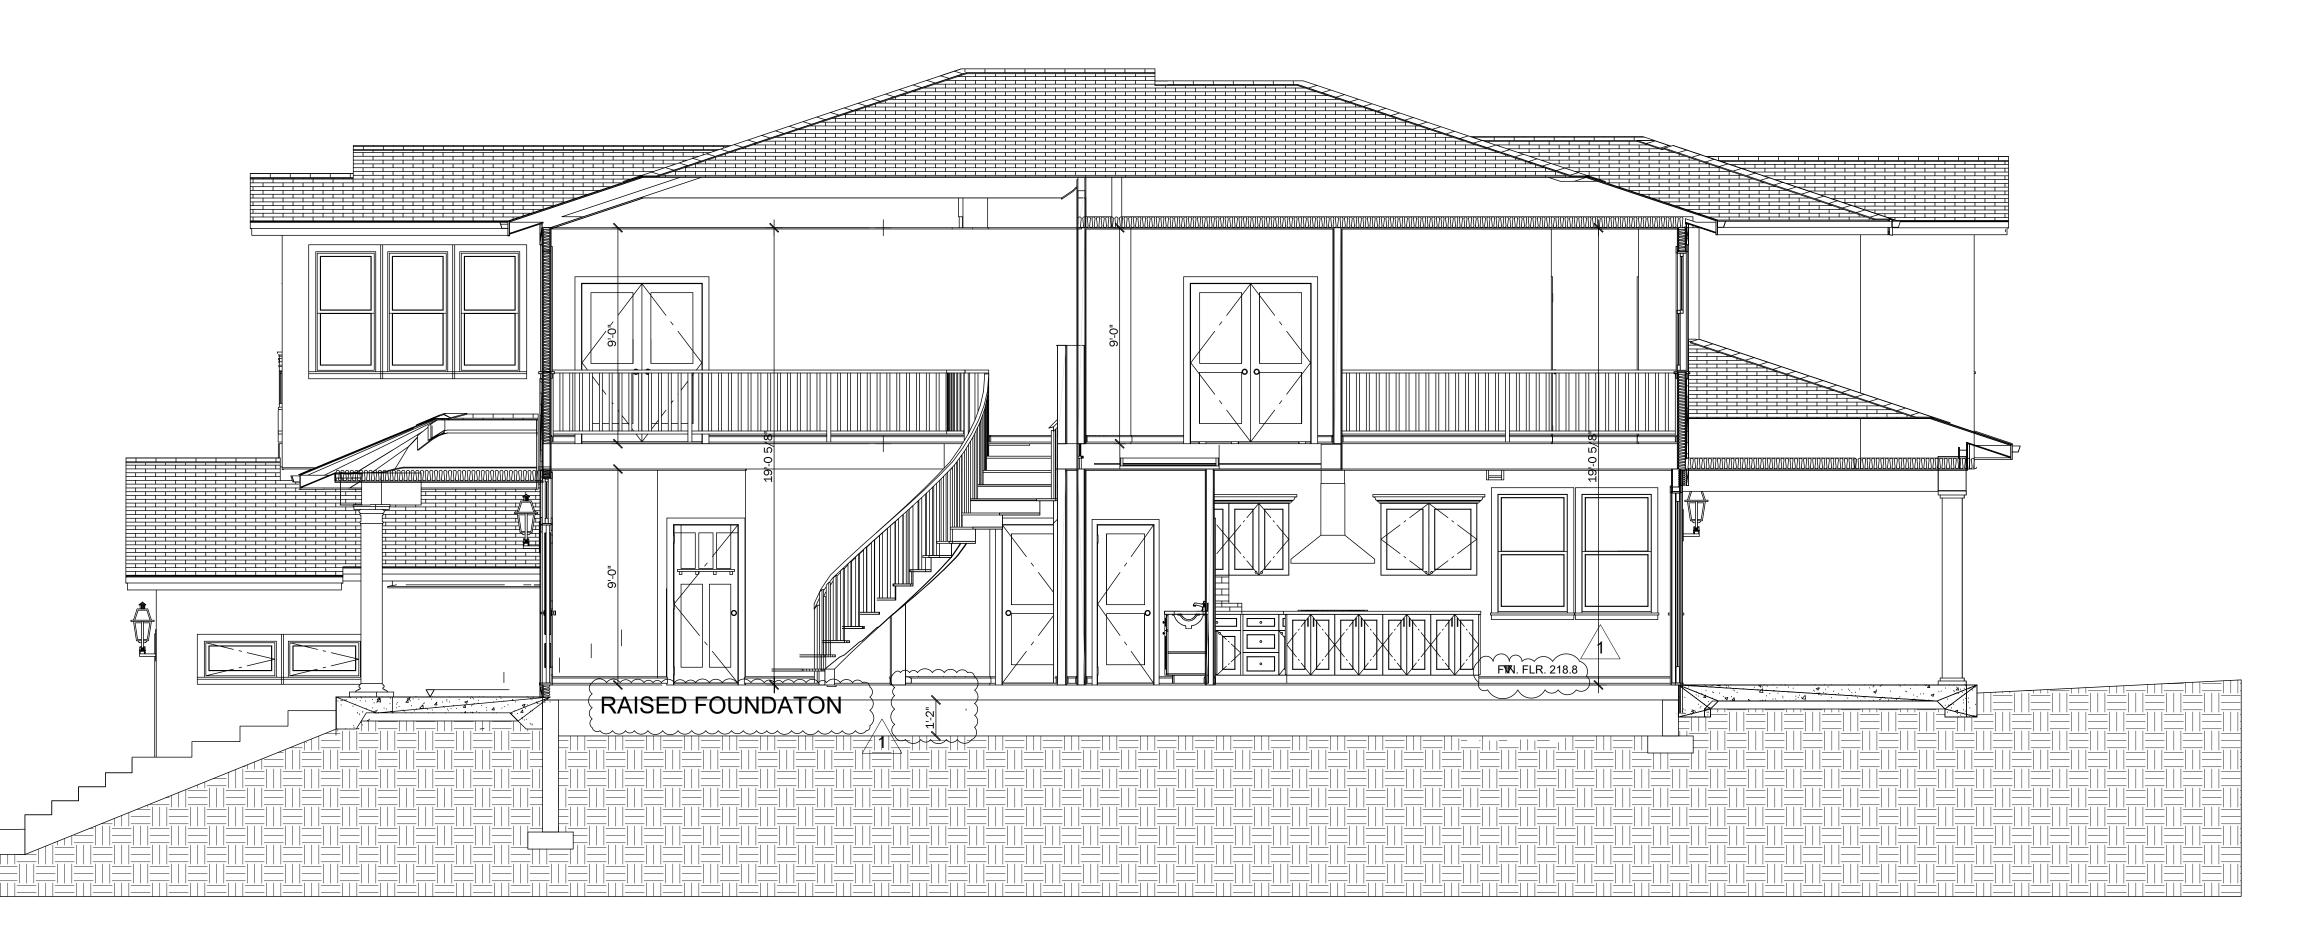

REV: DESCRIPTION:

7/10/2023 SHEET TITLE:

SECTIONS

SHEET NUMBER:











CONSULTANTS:

SEAL:

PROJECT NAME:




BODY: OMEGA TEXTURED STUCCO SIDING WITH SHERWIN WILLIAMS OYSTER BAR SW 7565



TRIM & ACCENT: SHERWIN WILLIAMS PURE WHITE SW 7005



ROOFING: CERTAINTEED LANDMARK PRO. DEF WEATHERED WOOD SHINGL

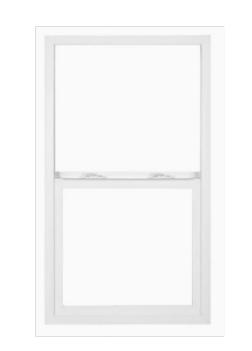

WINDOWS: SIMONTON -VINYL SINGLE HUNG



PATIO & BALCONY DOORS: SIMONTON -VINYL SLIDING FRENCH DOORS WHITE TRIM



COLPAY GARAGE DOORS: PAINTED METAL ROLL UP DOOR



ENTRY DOOR: DOUBLE **ENTRY DOORS WITH** WROUGHT IRON OVER GLASS PANELS. DURABLE **DARK WALNUT**



TYPICAL GUARD & HAND RAILING: WOOD NEWEL POST SQUARE WROUGHT IRON **BOLLARDS**



FIBERGLASS TUSCAN PORCH COLUMNS (PAINTED) WHITE TRIM




MINKA KIRKHAM 8 1/2" WIDE DARK SKY OUTDOOR WALL LIGHT

ALL HARDSCAPE WILL BE CONCRETE. WALK WAYS SHALL HAVE BROOM FINISH EXTERIOR STUCCO WILL BE BEIGE, WINDOWS - WHITE ROOF SHINGLES - BLACK GARAGE DOOR BROWN ENTRY DOOR - BROWN, LOCKS - BRUSHED NICKEL GUARD AND HAND RAIL - WHITE PORCH COLUMNS - WHITE LIGHT FIXTURES - BLACK /2

CUSTOM HOME RESIDENCE REV: DESCRIPTION: DATE: 7/10/2023 SHEET TITLE: SECTIONS

SHEET NUMBER:

A2.4

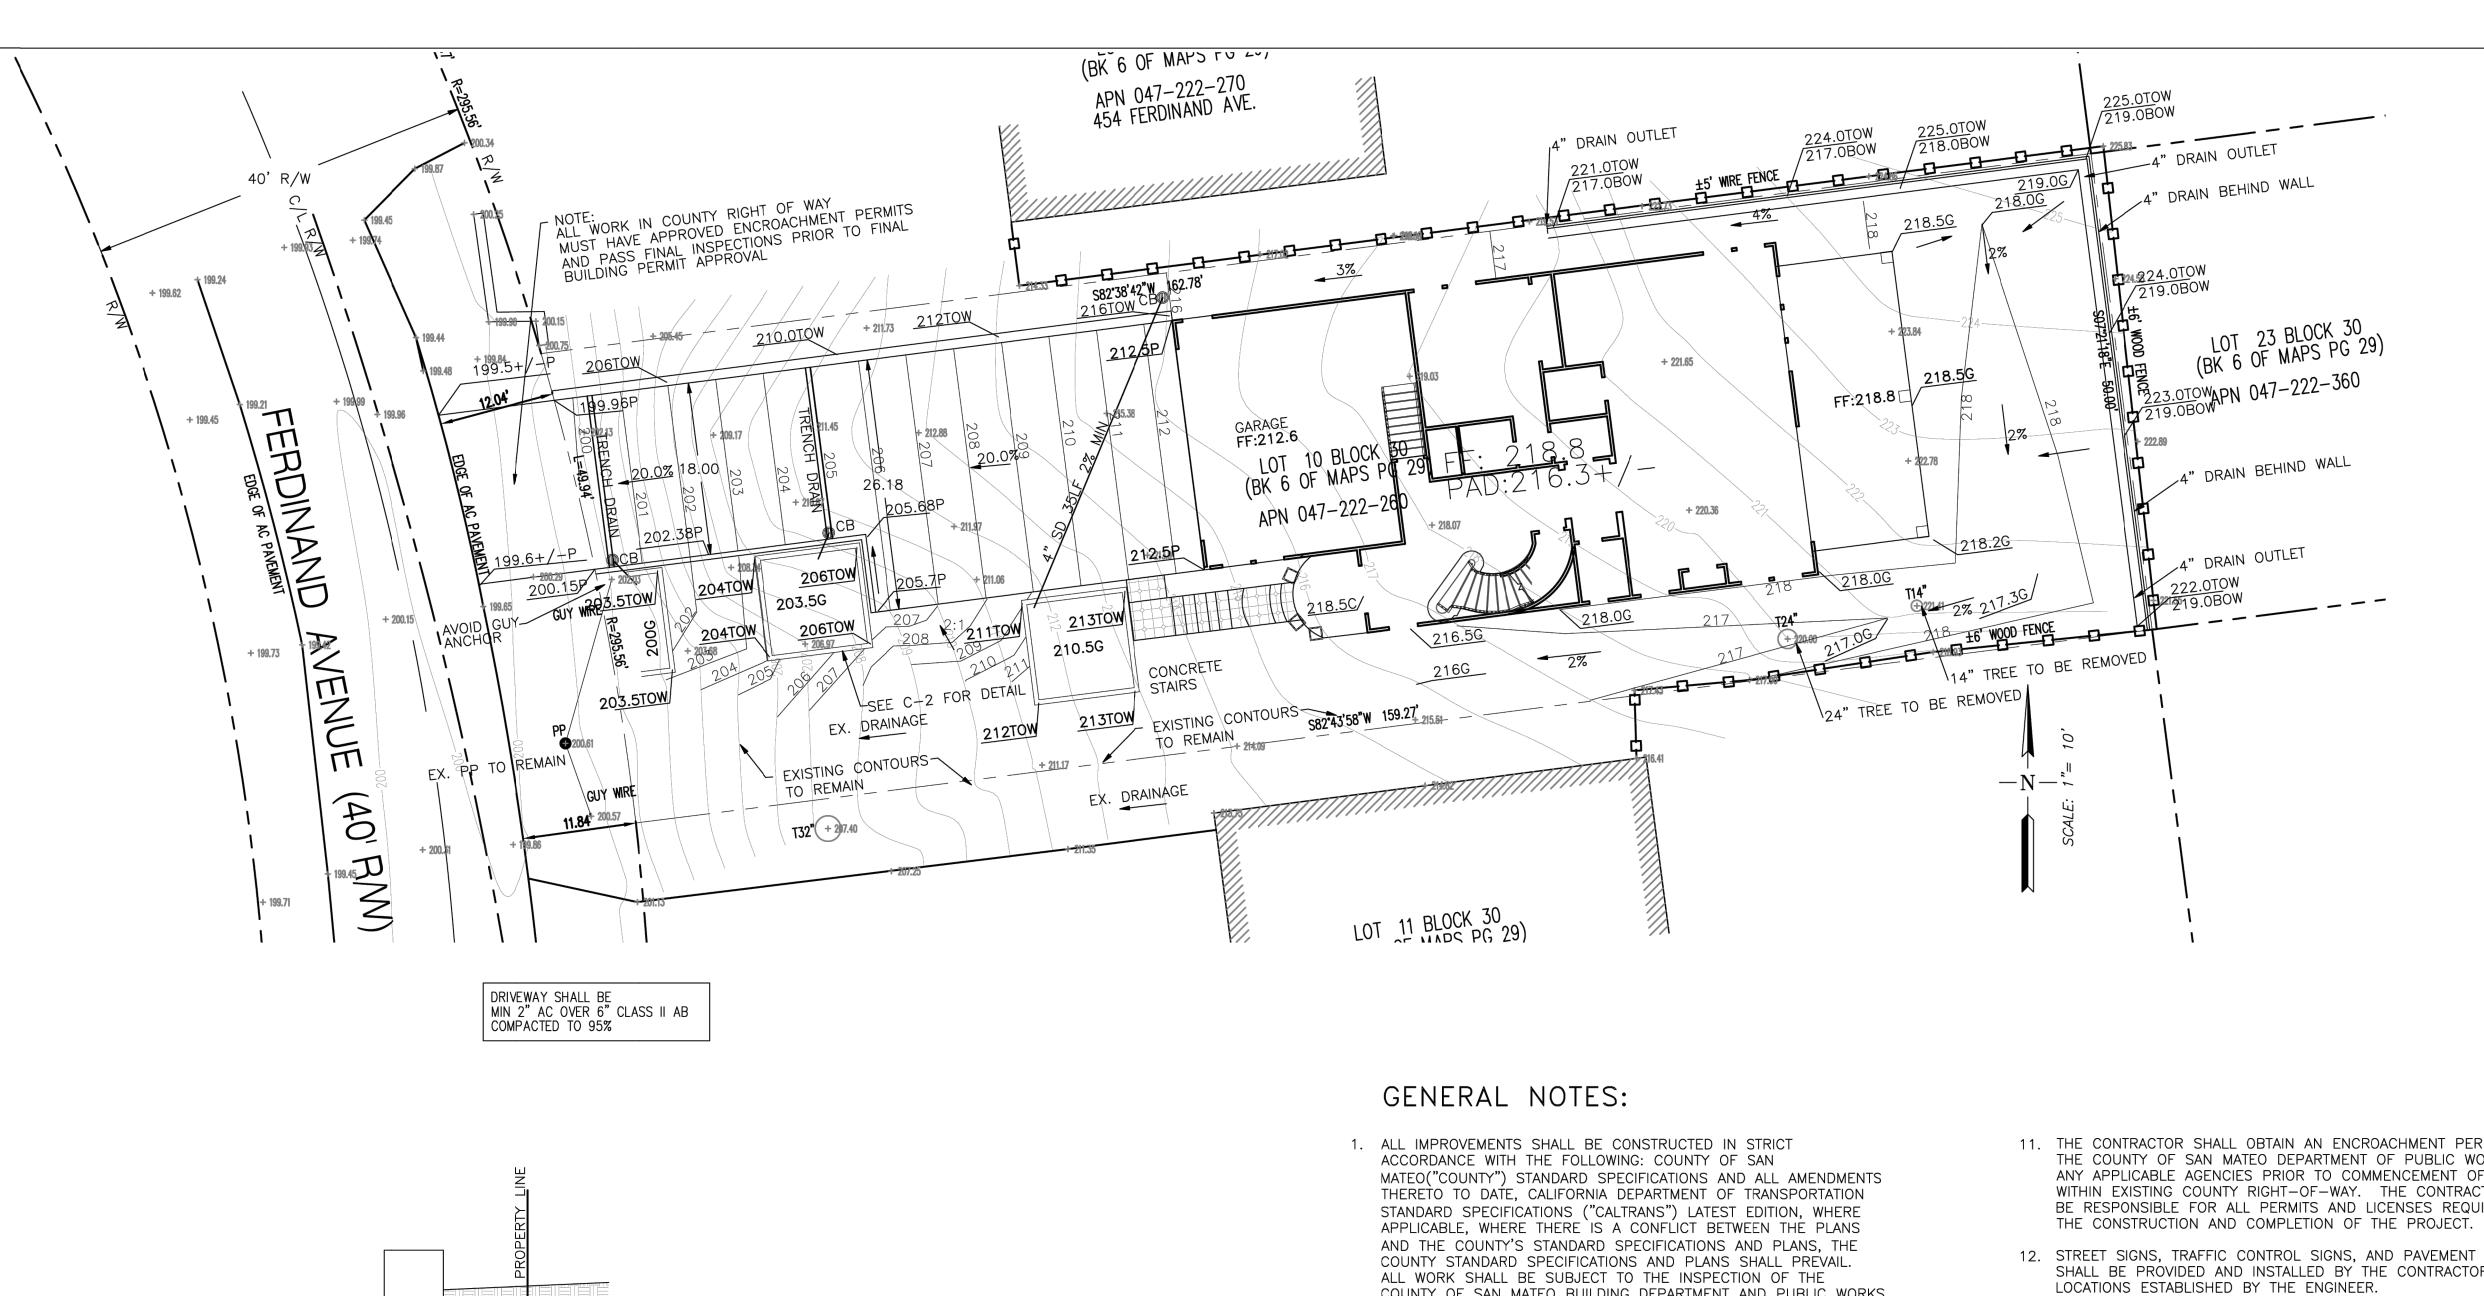

- CLEAN DRAIN ROCK

— 4" PERF. PIPE SDR35

WRAP PIPE WITH GEO-FABRIC

SLOPE: 2%

RETAINING WALL—

DRAINAGE PIPE DETAIL

BY OTHERS

CUT AND FILL:

NET: 390 CY (CUT)

ESTIMATES ARE FOR PLANNING PERMITS ONLY

RIM OF SANITARY SEWER MANHOLE ALONG FERDINAND AVENUE

ELEVATION 196.85 WAS USED AS A TEMPORARY BENCHMARK FOR

CUT: 400 CY

FILL: 10 CY

BENCH MARK:

THIS SURVEY.

- COUNTY OF SAN MATEO BUILDING DEPARTMENT AND PUBLIC WORKS DEPARTMENT.
- 2. PRIOR TO ANY WORK BEING PERFORMED, THE CONTRACTOR SHALL CONTACT THE APPROPRIATE REGULATORY AGENCIES FOR A PRE-CONSTRUCTION CONFERENCE.
- 3. IT IS INTENDED THAT THESE PLANS AND SPECIFICATIONS REQUIRE ALL LABOR AND MATERIALS NECESSARY AND PROPER FOR THE WORK COMTEMPLATED AND THAT THE WORK BE COMPLETED IN ACCORDANCE WITH THE TRUE INTENT AND PURPOSE. THE CONTRACTOR SHALL NOTIFY DUSPIVA ENGINEERING ("ENGINEER") IMMEDIATELY REGARDING ANY DISCREPANCIES AND AMBIGUITIES WHICH MAY EXIST IN THE PLANS AND SPECIFICATIONS. IF THE PLANS OR SPECIFICATIONS DESCRIBE PORTIONS OF THE WORK IN GENERAL TERMS BUT NOT IN COMPLETE DETAIL. IT IS UNDERSTOOD THAT ONLY THE BEST GENERAL PRACTICE IS TO PREVAIL AND THAT ONLY MATERIALS AND WORKMANSHIP OF THE FIRST QUALITY ARE TO BE USED.
- 4. THE CONTRACTOR SHALL EXERCISE DUE CAUTION AND SHALL CAREFULLY PRESERVE BENCH MARKS, REFERENCE POINTS AND ALL SURVEY STAKES, AND SHALL BEAR ALL EXPENSE FOR REPLACEMENT AND/OR ERRORS CAUSED BY THEIR UNNECESSARY LOSS OR DISTURBANCE.
- 5. CONTRACTOR AGREES THAT HE SHALL ASSUME SOLE AND COMPLETE RESPONSIBILITY FOR JOB SITE CONDITIONS DURING THE COURSE OF CONSTRUCTION OF THIS PROJECT, INCLUDING SAFETY OF ALL PERSONS AND PROPERTY. THAT THIS REQUIREMENT SHALL APPLY CONTINUOUSLY AND NOT BE LIMITED TO NORMAL WORKING HOURS; AND THAT THE CONTRACTOR SHALL DEFEND, INDEMNIFY AND HOLD THE OWNER, ENGINEER AND THE COUNTY HARMLESS FROM ANY AND ALL LIABILITY, REAL OR ALLEGED, IN CONNECTION WITH THE PERFORMANCE OF WORK ON THIS PROPERTY, EXCEPTING FOR LIABILITY ARISING FROM THE SOLE NEGLIGENCE OF THE OWNER OR THE ENGINEER.
- 6. THE CONTRACTOR SHALL BE HELD RESPONSIBLE FOR ANY FIELD CHANGES MADE WITHOUT WRITTEN AUTHORIZATION FROM THE COUNTY AND OR ENGINEER.
- 7. THE CONTRACTOR SHALL PROVDE ALL LIGHTS, SIGNS, BARRICADES, FLAGMEN, OR OTHER DEVICES NECESSARY FOR PUBLIC SAFETY IN ACCORDANCE WITH THE LATEST CALTRANS MANUAL.
- 8. THE OFFICE OF THE COUNTY OF SAN MATEO BUILDING DEPARTMENT AND PUBLIC WORKS DEPARTMENT SHALL BE NOTIFIED AT LEAST 48 HOURS IN ADVANCE OF ANY WORK.
- 9. CABLE TV, ELECTRICAL, GAS, AND TELEPHONE UNDERGROUND SHALL BE COMPLETED PRIOR TO CONSTRUCTION OF THE CURB, GUTTER, SIDEWALK AND PAVING.
- 10. THE COUNTY OF SAN MATEO OR ASSOCIATED UTILITY COMPANY AND RESIDENCES TO BE AFFECTED SHALL BE NOTIFIED IMMEDIATELY UPON ANY UTILITY SERVICE DISRUPTION OTHER THAN SPECIFIED ON THESE IMPROVEMENT PLANS AND A TWENTY-FOUR (24) HOUR NOTICE SHALL BE GIVEN FOR ANY PLANNED DISRUPTION.

- 11. THE CONTRACTOR SHALL OBTAIN AN ENCROACHMENT PERMIT FROM THE COUNTY OF SAN MATEO DEPARTMENT OF PUBLIC WORKS OR ANY APPLICABLE AGENCIES PRIOR TO COMMENCEMENT OF WORK WITHIN EXISTING COUNTY RIGHT-OF-WAY. THE CONTRACTOR SHALI BE RESPONSIBLE FOR ALL PERMITS AND LICENSES REQUIRED FOR
- 12. STREET SIGNS, TRAFFIC CONTROL SIGNS, AND PAVEMENT MARKINGS SHALL BE PROVIDED AND INSTALLED BY THE CONTRACTOR AT
- 13. CONTRACTOR IS RESPONSIBLE FOR COORDINATION OF THE REMOVAL OR RELOCATION OF ALL EXISTING UTILITIES WITH RESPECTIVE
- 14. ASPHALT CONCRETE SHALL BE PLACED ONLY WHEN THE
- 15. PRIOR TO COMMENCING ANY WORK, IT SHALL BE THE CONTRACTOR'S RESPONSBILITY TO HAVE EACH UTILITY COMPANY LOCATE IN THE FIELD, THEIR MAIN AND SERVICE LINES. THE CONTRACTOR SHALL NOTIFY MEMBERS IF THE UNDERGROUND SERVICE ALERT (U.S.A.) FORTY-EIGHT 48 HOURS IN ADVANCE OF PERFORMING ANY EXCAVATION WORK BY CALLING THE TOLL-FREE U.S.A. ORDER NUMBER. IT SHALL BE THE CONTRACTOR'S SOLE RESPONSIBILITY TO PROTECT ALL EXISTING UTILITIES SO THAT NO DAMAGE RESULTS TO THEM DURING THE PREFORMANCE OF THE REQUIRED TO COOPERATE WITH OTHER CONTRACTORS AND UTILITY COMPANIES INSTALLING NEW STRUCTURES, UTILITIES AND SERVICE TO THE DEVELOPMENT.
- EXISTING IMPROVEMENTS FROM DAMAGE. COST OF REPLACING EXISTING IMPROVEMENTS SHALL BE INCLUDED IN THE UNIT PRICE BID FOR ITEMS REQUIRING REMOVAL AND REPLACEMENT OF EXISTING IMPROVEMENTS.
- 17. WHENEVER PAVEMENT IS BROKEN OR CUT IN THE INSTALLATION OF THE WORK COVERED BY THESE PLANS AND SPECIFICATIONS, THE PAVEMENT SHALL BE REPLACED, AFTER PROPER BACK FILLING, WITH PAVEMENT MATERIALS EQUAL TO OR BETTER THAN THE

SHEET INDEX

18. PAYMENT FOR PAVEMENT WILL BE MADE ONLY FOR AREAS SHOWN ON THESE PLANS. REPLACEMENT OF PAVEMENT WHICH IS BROKEN OR CUT DURING THE INSTALLATION OF THE WORK COVERED BY

SHALL BE INDICATED IN THE CONTRACTOR'S UNIT PRICE FOR

PAVEMENT, AND NO ADDITONAL PAYMENT SHALL BE MADE FOR

19. EXCAVATIONS OF 5 FEET OR MORE IN DEPTH WILL REQUIRE AN EXCAVATION PERMIT FROM THE STATE OF CALIFORNIA DEPARTMENT OF INDUSTRIAL SAFETY. FOR TRENCHES 5 FEET OR MORE IN

20. WE CALL YOUR ATTENTION TO TITLE 8 CALIFORNIA ADMINISTRATION

CODE SECTION 1540 (A) (1) OF THE CONSTRUCTION SAFETY

ORDERS ISSUED BY THE OCCUPATIONAL SAFETY AND HEALTH STANDARDS BOARD PURSUANT TO THE CALIFORNIA OCCUPATIONS SAFETY AND HEALTH ACT OF 1973 AS AMENDED WHICH STATES (1) PRIOR TO OPENING AN EXCAVATION EFFORT SHALL BE MADE TO DETERMINE WHETHER UNDERGROUND INSTALLATIONS; I.E. SEWER

OF SUCH INSTALLATION, THE EXACT LOCATION SHALL BE

THE EXISTING INSTALLATION ALL KNOWN OWNERS OF

WATER, FUEL, ELECTRICAL LINES, ETC, WILL BE ENCOUNTERED AND IF SO, WHERE SUCH UNDERGROUND INSTALLATIONS ARE LOCATED. WHEN THE EXCAVATION APPROACHES THE APPROXIMATE LOCATION

DETERMINED BY CAREFUL PROBING OR HAND DIGGING; AND, WHEN

IT IS UNCOVERED, ADEQUATE PROTECTION SHALL BE PROVIDED FOR

21. ALL TRENCHES IN PAVED AREAS SHALL BE PAVED WITH TEMPORARY

AND STRENGTH, THE SAME DAY THE PAVEMENT CUT IS MADE.

22. SIGNING, STRIPING AND PAVEMENT MARKINGS SHALL BE IN STRICT

1. EARTHWORK SHALL BE PERFORMED IN ACCORDANCE WITH THE

2. THE DEVELOPER SHALL BE RESPONSIBLE FOR COST OF INITIAL

3. THE CONTRACTOR SHALL REVIEW SITE PRIOR TO BIDDING. ALL

4. CONTRACTOR'S PRICE SHALL INCLUDE COST TO IMPORT AND

BE INCLUDED IN THE LUMP SUM CLEARING COST.

IF THE FIRST TEST FAILS, THE CONTRACTOR SHALL BE

TRAFFIC CONTROL DEVICES (MUTCD).

GRADING NOTES:

SUBSEQUENT CURVES AND TESTS.

OF ANY AND ALL EXCESS DIRT.

FINAL EARTHWORK QUANTITIES.

CAN BE MADE.

PAVING, OR COVERED WITH A STEEL PLATE OR APPROPIATE SIZE

CONFORMANCE WITH THE LATEST CALTRANS MANUAL ON UNIFORM

COUNTY OF SAN MATEO STANDARDS. ALL FILL AREAS SHALL BE

COMPACTED TO 95% R.C UNLESS OTHERWISE SPECIFIED. THE

DEVELOPER SHALL BE RESPONSIBLE FOR COST OF INITIAL TEST.

TEST FOR MOISTURE DENSITY CURVE. IF THE FIRST TEST FAILS,

THE CONTRACTOR SHALL BE RESPONSIBLE FOR COST OF ALL

VEGETATION AND DELETERIOUS MATERIALS SHALL BE REMOVED

EXPORT MATERIAL AS NEEDED BASED ON THE GRADING PLAN

5. CONTRACTOR IS RESPONSIBLE FOR THE OFF HAUL AND DISPOSAL

6 THE CUT AND FILL VALUES SHOWN ON THE GRADING PLAN ARE

CONTRACTOR DURING GRADING OPERATIONS, NOR CAN THE

ENGINEER GUARANTEE THE EXACT SOIL CONDITIONS OVER THE

ENTIRE SITE, THE ENGINEER ASSUMES NO RESPONSIBILITY FOR

7. THE CONTRACTOR SHALL BE RESPONSIBLE FOR DETERMINING HIS OWN EARTHWORK QUANTITIES FOR BIDDING, CONTRACT AND ADDITIONAL OF THE CONTRACT AND ADDITIONAL OF

CONSTRUCTION PURPOSE. IF IT APPEARS THERE WILL BE AN

8. CONTRACTOR SHALL PROVIDE A SMOOTH TRANSITION FROM THE)

PROPOSED IMPROVEMENTS TO THE EXISTING IMPROVEMENTS.

SHALL BE IN ACCORDANCE WITH SECTION 10 OF CALTRANS

STANDARD SPECIFICATIONS AND THE REQUIREMENTS OF THE

MEANS OF WATER STORAGE AND SUPPLY FOR DUST CONTROL.

CONTRACTOR'S EXPENSE TO MINIMIZE ANY DUST NUISANCE AND

COUNTY OF SAN MATEO. CONTRACTOR SHALL PROVIDE THEIR OWN

9 DUST CONTROL SHALL BE PROVIDED AT ALL TIMES, AT THE

EXCESS OR SHORTAGE OF MATERIAL, THE CONTRACTOR MAY NOTIFY

THE ENGINEER TO DETERMINE IF POSSIBLE GRADE ADJUSTMENTS

ATTACHED. THE GRADES SHOWN ON THE GRADING PLAN SHALL

NOT CHANGE WITHOUT WRITTEN AUTHORIZATION OF THE ENGINEER.

FOR REFERENCE AND FEE PURPOSES ONLY. SINCE THE ENGINEER CAN NOT CONTROL THE EXACT METHOD OR MEANS USED BY THE

FROM THE SITE AT THE EXPENSE OF THE CONTRACTOR AND SHALL

DEPTH, THE CONTRACTOR SHALL COMPLY WITH SECTION 5-1.02A OF THE CALTRANS STANDARDS, CHAPTER 9 OF THE STATE OF CALIFORNIA LABOR CODE, AND ANY LOCAL CODES OR ORDINANCES.

SUCH WORK.

THESE SPECIFICATIONS, AND WHICH LIES OUTSIDE OF SAID AREAS,

GRADING AND DRAINAGE PLAN **PROFILE**

TOPOGRAPHIC PLAN

C-2C-3EROSION CONTROL PLAN STORM DRAINAGE AREAS

REVISIONS	DATE		
REV	DESCRIPTIONS		
	70.		

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AVENUE \sim

RESPONSIBLE FOR COST OF ALL SUBSEQUENT CURVES AND TESTS.

SHEET NUMBER

1 OF 4

UNDERGROUND FACILITIES IN THE AREA CONCERNED SHALL BE ADVISED OF PROPOSED WORK AT LEAST FORTY-EIGHT (48) HOURS PRIOR TO THE STATE OF ACTUAL EXCAVATION.


UTILITY COMPANIES.


ATMOSPHERIC TEMPERATURE IS ABOVE 50°.


NUMBER (800) 227-2600. THE CONTRACTOR SHALL RECORD THE CONTRACT. ANY REPAIRS NECESSARY TO DAMAGED UTILITIES SHALL BE PAID FOR BY THE CONTRACTOR. THE CONTRACTOR SHALL BE

16. THE CONTRACTOR SHALL BE RESPONSIBLE FOR PROTECTING

MATERIAL USED IN THE ORIGINAL PAVING. THE FINISHED PAVEMENT SHALL BE SUBJECT TO THE APPROVAL OF THE COUNTY ENGINEER.

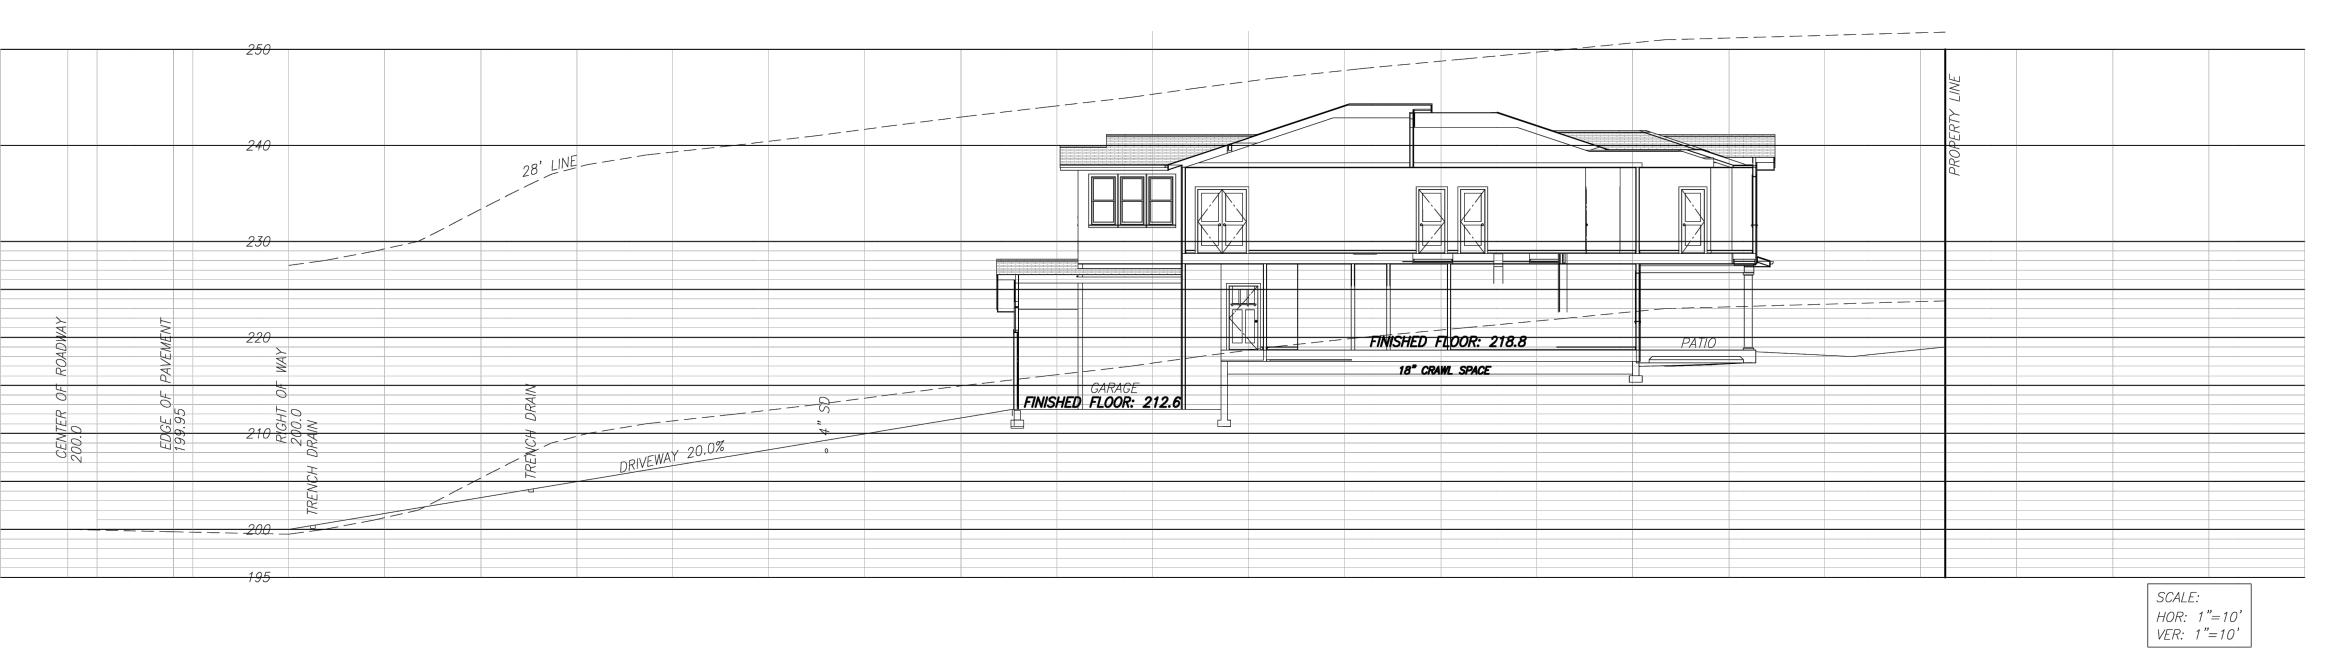

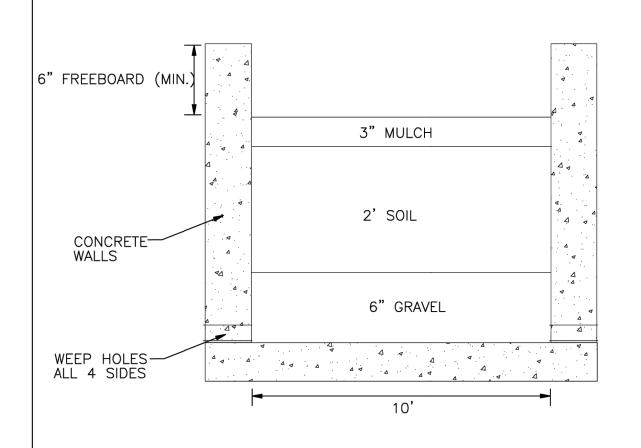


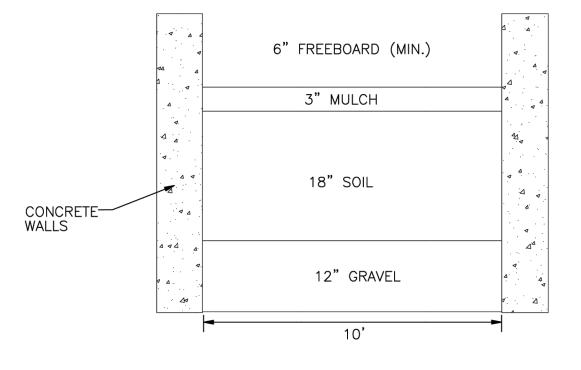



RAIN GARDEN TYPICAL DETAIL

PLANTER BOX TYPICAL DETAIL

2 OF 4

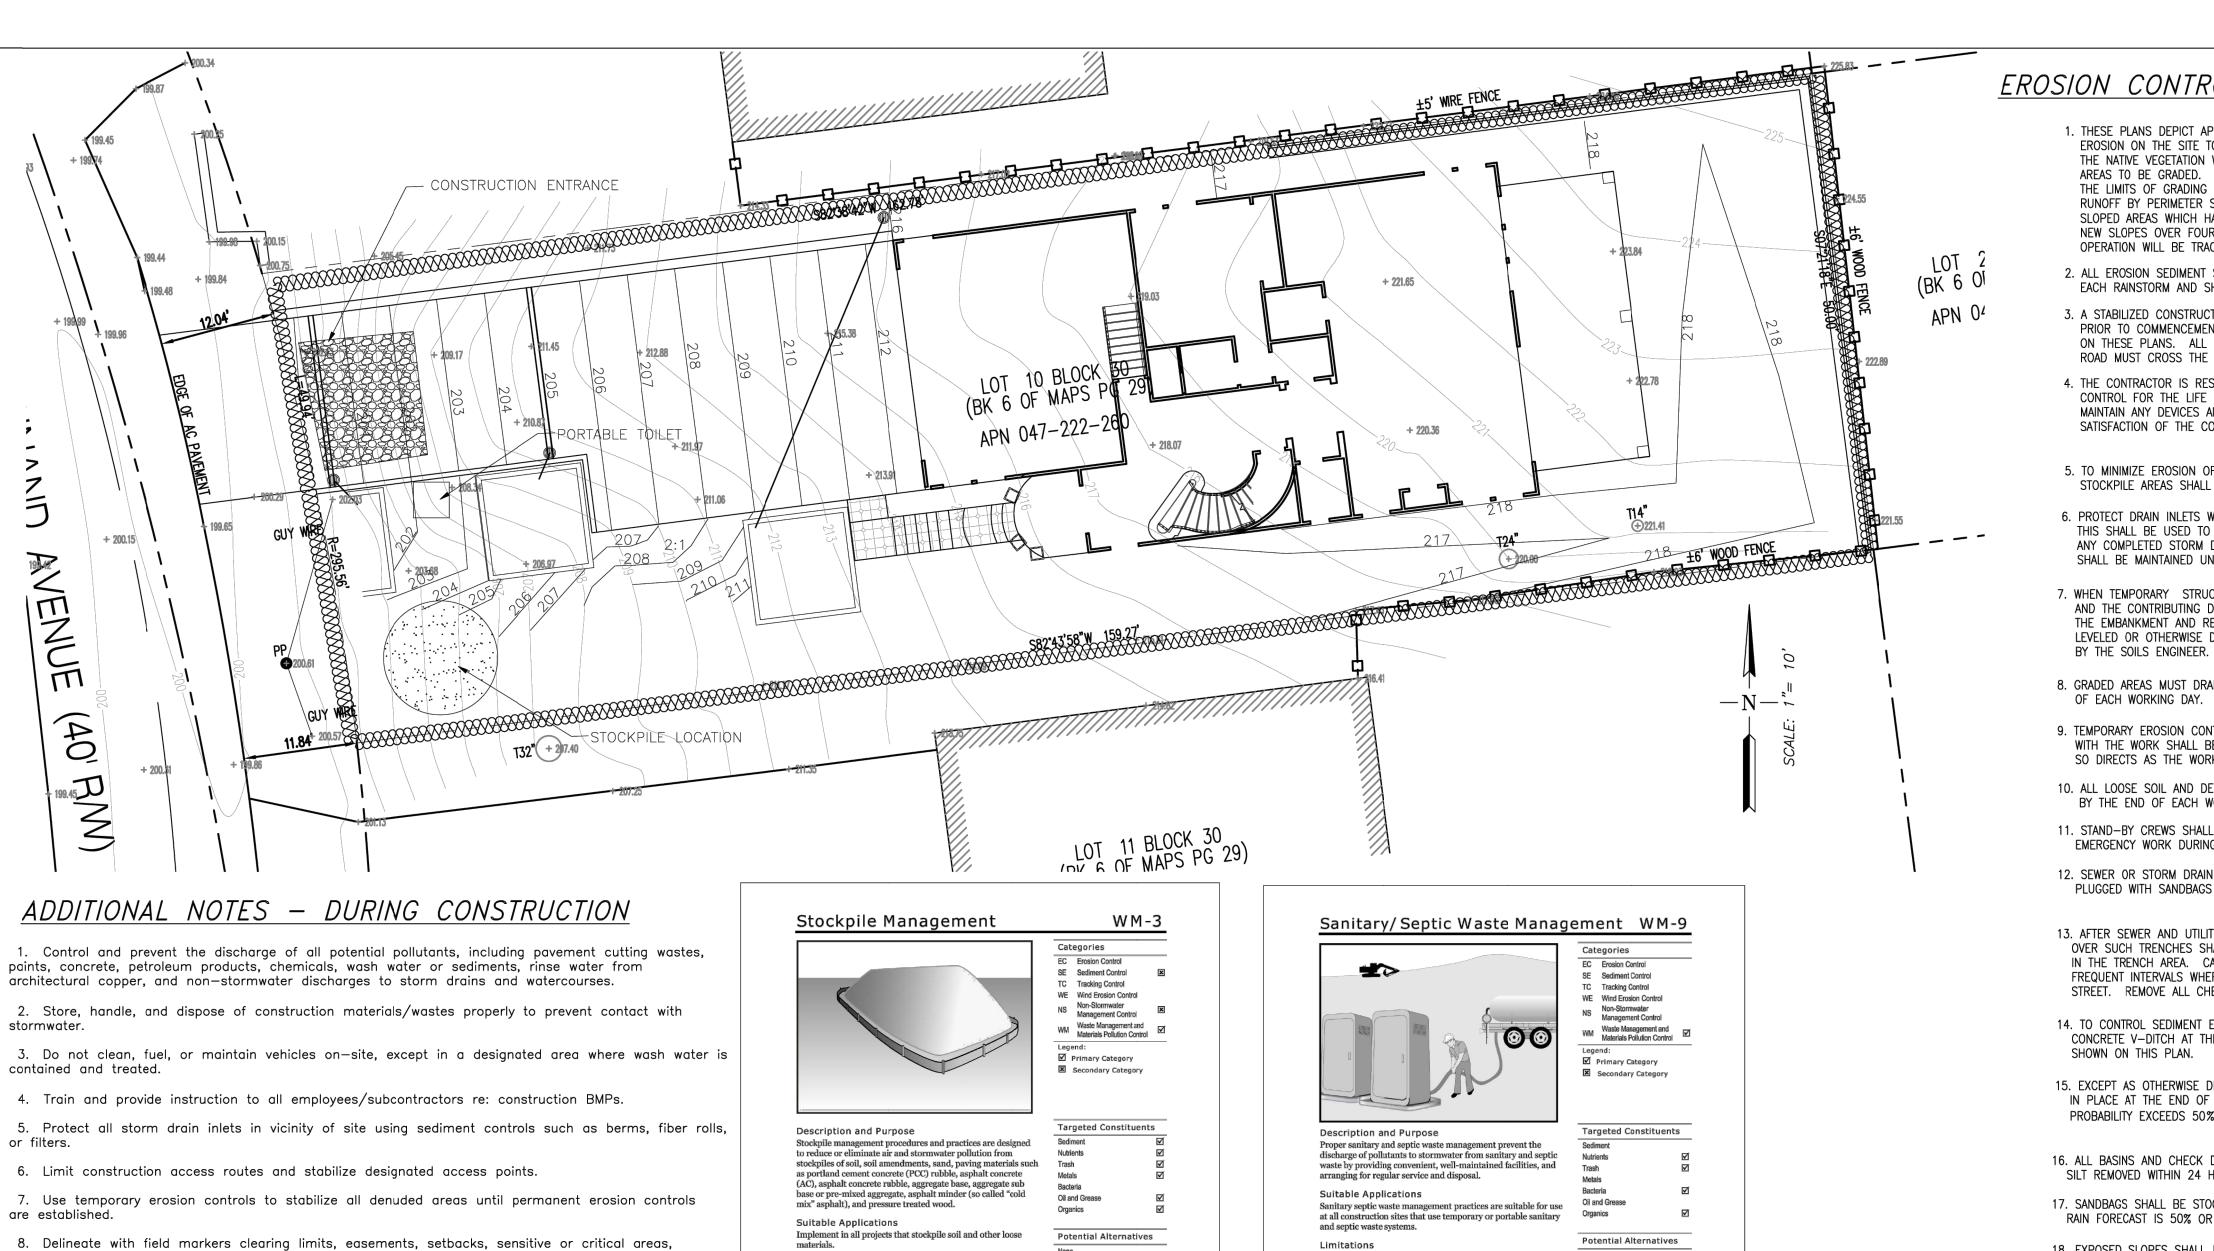

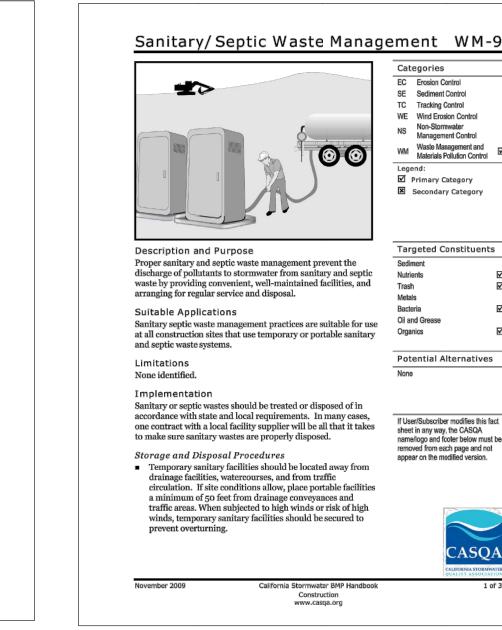

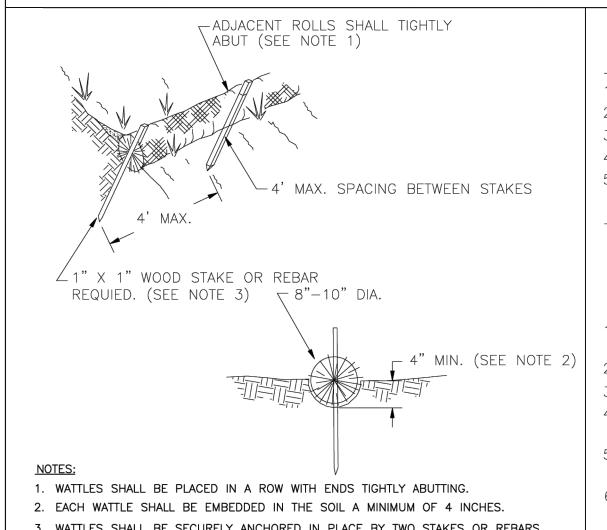

buffer zones, trees, and drainage courses.

and dikes).

NOT TO SCALE

9. Perform clearing and earth moving activities only during dry weather.

silt fences, check dams, soil blankets or mats, covers for soil stock piles, etc.

10. Trap sediment on—site, using BMPs such as sediment basins or traps, earthen dikes or berms,

11. Divert on—site runoff around exposed areas; divert off—site runoff around the site (e.g., swales

12. Protect adjacent properties and undisturbed areas from construction impacts using vegetative

buffer strips, sediment barriers or filters, dikes, mulching, or other measures as appropriate.

3. WATTLES SHALL BE SECURELY ANCHORED IN PLACE BY TWO STAKES OR REBARS DRIVEN THROUGH THE WATTLES. THE FIRST STAKE IN EACH WATTLE SHALL

4. THE DIKE SHALL BE INSPECTED AFTER EACH STORM, AND REPAIR OR REPLACEMENT SHALL BE MADE PROMPTLY AS NEEDED. THE WATTLES SHALL BE REMOVED ONCE THEY HAVE SERVED THEIR PURPOSE SO AS NOT TO BLOCK OR IMPEDE

FIBER ROLL (SE-5)

BE DRIVEN TOWARD THE PREVIOUSLY LAID WATTLE TO FORCE THE WATTLES TOGETHER.

5. CONTRACTOR MAY SUBSTITUTE WATTLE FOR SILT FENCE WITH APPROVAL OF COUNTY ENG

NOTES:

1. INTENTED FOR SHORT TERM USE.

2. USE TO INHIBIT NON-STORM WATER FLOW.

3. ALLOW FOR PROPER MAINTENANCE AND CLEAN UP.

4. BAGS MUST BE REMOVED AFTER ADJACENT OPERATION IS COMPLETED.

5. NOT APPLICABLE IN AREAS WITH HIGH SILTS AND CLAYS WITHOUT FILTER FABRIC.

Plastic sheeting as a stockpile protection is temporary and hard to manage in windy conditions. Where plastic is used,

onsider use of plastic tarps with nylon reinforcement

Plastic sheeting can increase runoff volume due to lack of

■ The use of Plastic materials and photodegradable plastics

Protection of stockpiles is a year-round requirement. To

infiltration and potentially cause perimeter control failure.

sheet in any way, the CASQA

removed from each page and not appear on the modified version.

name/logo and footer below must be

which may be more durable than standard sheeting.

Plastic sheeting breaks down faster in sunlight.

should be avoided

D.I. PROTECTION TYPE 3 - GRAVEL BAG:


THE GRAVEL BAG BARRIER (TYPE 3) IS SHOWN IN THE FIGURES. FLOW FROM A SEVERE STORM SHOULD NOT OVERTOP THE CURB. IN AREAS OF HIGH CLAY AND SILTS, USE FILTER FABRIC AND GRAVEL AS ADDITIONAL FILTER MEDIA. GRAVEL BAGS SHOULD BE USED DUE TO THEIR HIGH PERMEABILITY.

1. USE SAND BAG MADE OF GEOTEXTILE FABRIC (NOT BURLAP) AND FILL WITH 0.75 IN ROCK OR 0.25 IN PEA GRAVEL.


2. CONSTRUCT ON GENTLY SLOPING STREETS. 3. LEAVE ROOM UPSTREAM OF BARRIER FOR WATER TO POND AND SEDIMENT TO SETTLE. 4. PLACE SEVERAL LAYERS OF SAND BAGS — OVERLAPPING THE BAGS AND

PACKING THEM TIGHTLY TOGETHER. 5. LEAVE GAP OF ONE BAG ON THE TOP ROW TO SERVE AS A SPILLWAY. FLOW FROM A SEVERE STORM (E.G. 10 YR STORM) SHOULD NOT OVERTOP THE CURB.

6. THIS DETAIL IS TO BE USED ON EXISTING STREETS WHERE SILTED FLOW IS TO BE INTERCEPTED (CAUGHT) PRIOR TO ENTERING THE STORM DRAIN SYSTEM. SANDBAGS CAN ALSO BE USED WHEN THE ROUGH GRADED STREETS HAVE POURED INPLACE CONCRETE SURROUNDING THE INLET TO CREATE A "FLOW LINE" WHERE A DAM CAN BE ACHIEVED TO PROTECT THE STORM SYSTEM FROM THE INFLOW OF SEDIMENT.

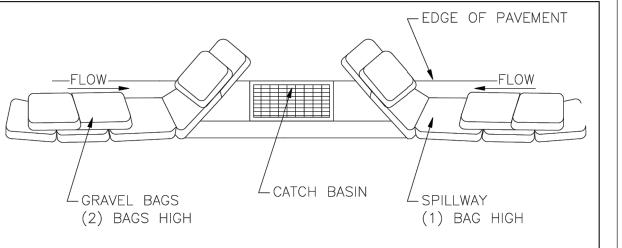

TYPICAL PROTECTION FOR INLET ON SUMP

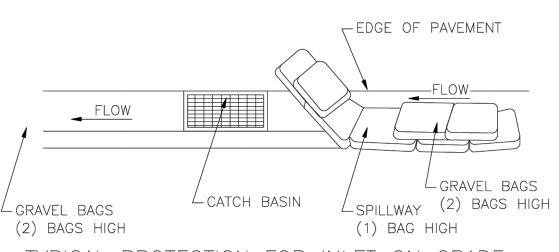

TYPICAL PROTECTION FOR INLET ON GRADE

DETAIL SE-10 - INLET PROTECTION

EROSION CONTROL GENERAL NOTES

1. THESE PLANS DEPICT APPROPRIATE MEASURES TO CONTROL EROSION ON THE SITE TO BE GRADED AS SHOWN ON THE PLANS THE NATIVE VEGETATION WILL BE REMOVED ONLY FROM THOSE AREAS TO BE GRADED. AREAS OUTSIDE OF AND DOWNSLOPE OF THE LIMITS OF GRADING WILL BE PROTECTED FROM SILT LADEN RUNOFF BY PERIMETER SILT FENCES AS DEPICTED ON THIS PLAN SLOPED AREAS WHICH HAVE BEEN STRIPPED OF VEGETATION AND NEW SLOPES OVER FOUR FEET HIGH CREATED DURING THE GRADING OPERATION WILL BE TRACKWALKED & HYDROSEEDED.

2. ALL EROSION SEDIMENT STRUCTURES SHALL BE INSPECTED AFTER EACH RAINSTORM AND SHALL BE CLEANED OUT AS NECESSARY.

3. A STABILIZED CONSTRUCTION ENTRANCE SHALL BE INSTALLED PRIOR TO COMMENCEMENT OF GRADING. THE LOCATION IS SHOWN ON THESE PLANS. ALL CONSTRUCTION TRAFFIC ENTERING THE PAVED ROAD MUST CROSS THE ENTRANCE.

4. THE CONTRACTOR IS RESPONSIBLE FOR ALL ASPECTS OF EROSION CONTROL FOR THE LIFE OF THE PROJECT AND SHALL INSTALL AND MAINTAIN ANY DEVICES AND MEASURES NECESSARY TO THE SATISFACTION OF THE COUNTY ENGINEER, ALL-YEAR ROUND.

5. TO MINIMIZE EROSION OF GRADED BANKS, ALL GRADED BANKS AND STOCKPILE AREAS SHALL BE HYDROSEEDED, LANDSCAPED OR SEALED.

PROTECT DRAIN INLETS WITH FILTER FABRIC ANCHORED BY PEA GRAVEL BAGS, THIS SHALL BE USED TO PREVENT SEDIMENT LADEN RUNOFF FROM ENTERING ANY COMPLETED STORM DRAIN INLETS. THESE PROTECTION MEASURES SHALL BE MAINTAINED UNTIL THE PROJECT IS COMPLETED.

7. WHEN TEMPORARY STRUCTURES HAVE SERVED THEIR INTENDED PURPOSE AND THE CONTRIBUTING DRAINAGE AREA HAS BEEN PROPERLY STABILIZED. THE EMBANKMENT AND RESULTING SEDIMENT DEPOSITS ARE TO BE LEVELED OR OTHERWISE DISPOSED OF BY THE CONTRACTOR AS RECOMMENDED

8. GRADED AREAS MUST DRAIN AWAY FROM THE FACE OF SLOPES AT THE CONCLUSION OF EACH WORKING DAY. DRAINAGE SHALL BE DIRECTED TOWARDS DRAINAGE INLETS.

9. TEMPORARY EROSION CONTROL DEVICES SHOWN ON THIS PLAN WHICH INTERFERE WITH THE WORK SHALL BE RELOCATED OR MODIFIED AS AND WHEN THE INSPECTOR SO DIRECTS AS THE WORK PROGRESSES.

10. ALL LOOSE SOIL AND DEBRIS SHALL BE REMOVED FROM THE PUBLIC RIGHT-OF-WAY BY THE END OF EACH WORKING DAY.

11. STAND-BY CREWS SHALL BE ALERTED BY THE PERMITTEE OR CONTRACTOR FOR EMERGENCY WORK DURING RAINSTORMS.

12. SEWER OR STORM DRAIN TRENCHES THAT DRAIN THROUGH BASIN DIKES SHALL BE PLUGGED WITH SANDBAGS FROM TOP OF PIPE TO TOP OF DIKE.

13. AFTER SEWER AND UTILITY TRENCHES ARE BACKFILLED AND COMPACTED, THE SURFACES OVER SUCH TRENCHES SHALL BE MOUNDED SLIGHTLY TO PREVENT CHANNELING OF WATER IN THE TRENCH AREA. CARE SHOULD BE EXERCISED TO PROVIDE FOR CROSS-FLOW AT FREQUENT INTERVALS WHERE TRENCHES ARE NOT ON THE CENTERLINE OF A CROWNED STREET. REMOVE ALL CHECK DAMS PRIOR TO BACKFILL.

14. TO CONTROL SEDIMENT ENTERING FIELD INLETS, PLACE PEA GRAVEL BAGS IN THE CONCRETE V-DITCH AT THE SIDE OPENING OF THE FIELD INLET AT THE LOCATIONS SHOWN ON THIS PLAN.

15. EXCEPT AS OTHERWISE DIRECTED BY THE INSPECTOR. ALL DEVICES SHOWN SHALL BE IN PLACE AT THE END OF EACH WORKING DAY WHEN THE FORECAST OF RAIN PROBABILITY EXCEEDS 50% AND MAINTAINED YEAR-ROUND.

16. ALL BASINS AND CHECK DAMS SHALL HAVE BEEN PUMPED DRY, AND ALL DEBRIS AND SILT REMOVED WITHIN 24 HOURS AFTER EACH STORM.

17. SANDBAGS SHALL BE STOCKPILED ON-SITE, READY TO BE PLACED IN POSITION WHEN RAIN FORECAST IS 50% OR WHEN DIRECTED BY THE INSPECTOR.

18. EXPOSED SLOPES SHALL BE PROTECTED BY VEGETATION COVER OR FABRIC COVER AS APPROVED BY THE COUNTY ENGINEER. 19. Provide secondary containment structures (not double wall containers) where wet

install Harrest dang a lend carious.

ialia di Filenter Slapsi

ifornia Stormwater BMP Handbook Porta

www.casqa.org

If more than one fiber roll is placed in a row, the rolls must be overlapped, not abutted

Turn the ends of the fiber roll up-slope to prevent runoff from going around the roll.

SE-5

leaking tanks, or equipment, or any other unplanned releases.

Fiber Rolls

LEGEND

'WWW WATTLE) SEE DETAIL THIS SHEET

INLET PROTECTION

material processing occurs (e.g., electroplating), to hold spills resulting from accidents CONSTRUCT SEDIMENT BARRIEF SEDIMENT TRAP AND CHANNELIZE RUNOFF TO -SEDIMENT TRAPPING DEVICE (OPTIONAL) CORRUGATED STEEL PANELS СФМОДАТЕ ANTICIPATED '← 24' MIN. — TEMP. PIPE CULVERT 50' MIN. OR FOUR TIMES THE CIRCUMFERENCE THE LARGEST CONSTRUCTION VEHICLE TIRE, WHICHEVER IS GREATER -CRUSHED AGGREGATE GREATER THAN 3" BUT SMALLER THAN 6"12" MIN. UNLESS OTHERWISE -ORIGINAL GROUND SPECIFIED BY A SOILS ENGINEER - FILTER FABRIC

> SECTION A-A (OPTIONAL) CORRUGATED STEEL PANELS MIN. UNLESS OTHERWISE 2 SPECIFIED BY A SOILS ENGINEER H 7

- CRUSHED AGGREGATE GREATER THAN 3" BUT SMALLER THAN 6


1. THE CONTRACTOR SHALL CONSTRUCT A STABILIZED CONSTRUCTION ENTRANCE/EXIT AT EACH ENTRANCE/EXIT TO THE PROJECT SITE AND SHALL BE CONSTRUCTED ON LEVEL GROUND.

2. THE ENTRANCE SHALL BE MAINTAINED IN A CONDITION THAT WILL PREVENT TRACKING OR $^{
m t}$ FLOWING OF SEDIMENT ONTO PUBLIC RIGHT-OF-WAY. THIS MAY REQUIRE PREIODIC TOP DRESSING WITH ADDITIONAL STONE AS CONDITIONS DEMAND, AND REPAIR AND/OR CLEAN OUT ANY MEASURES USED TO TRAP SEDIMENT, ALL SEDIMENT SPILLED, DROPPED, WASHED OR TRACKED ONTO PUBLIC RIGHT-OF-WAY SHALL BE REMOVED IMMEDIATELY

3. WHEN NECESSARY, WHEELS SHALL BE CLEANED TO REMOVE SEDIMENT PRIOR TO ENTRANCE ONTO PUBLIC RIGHT-OF-WAY. WHEN WASHING IS REQUIRED, IT SHALL BE DONE ON AN AREA STABILIZED WITH CRUSH STONE THAT DRAINS INTO AN APPROVED SEDIMENT TRAP, OR SEDIMENT BASIN. ALL SEDIMENT SHALL BE PREVENTED FROM ENTERING ANY STORM DRAIN, DITCH, OR WATERCOURSE THROUGH USE OF GRAVEL BAGS, GRAVEL BOARDS, OR OTHER APPROVED METHODS.

4. CONTRACTOR SHALL REMOVE AND DISPOSE OF STABILIZED CONSTRUCTION ENTRANCE UPON COMPLETION OF CONSTRUCTION.

STABILIZED CONSTRUCTION ENTRANCE/EXIT (TC-1)

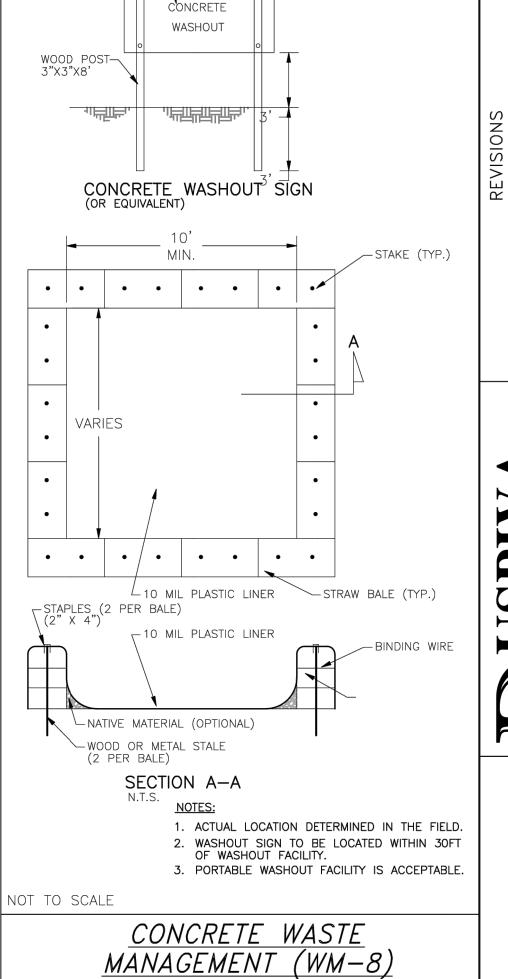

-PLYWOOD (48"X24")


SCREWS

-BLACK LETTERS

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SHEET NUMBER

3 OF 4

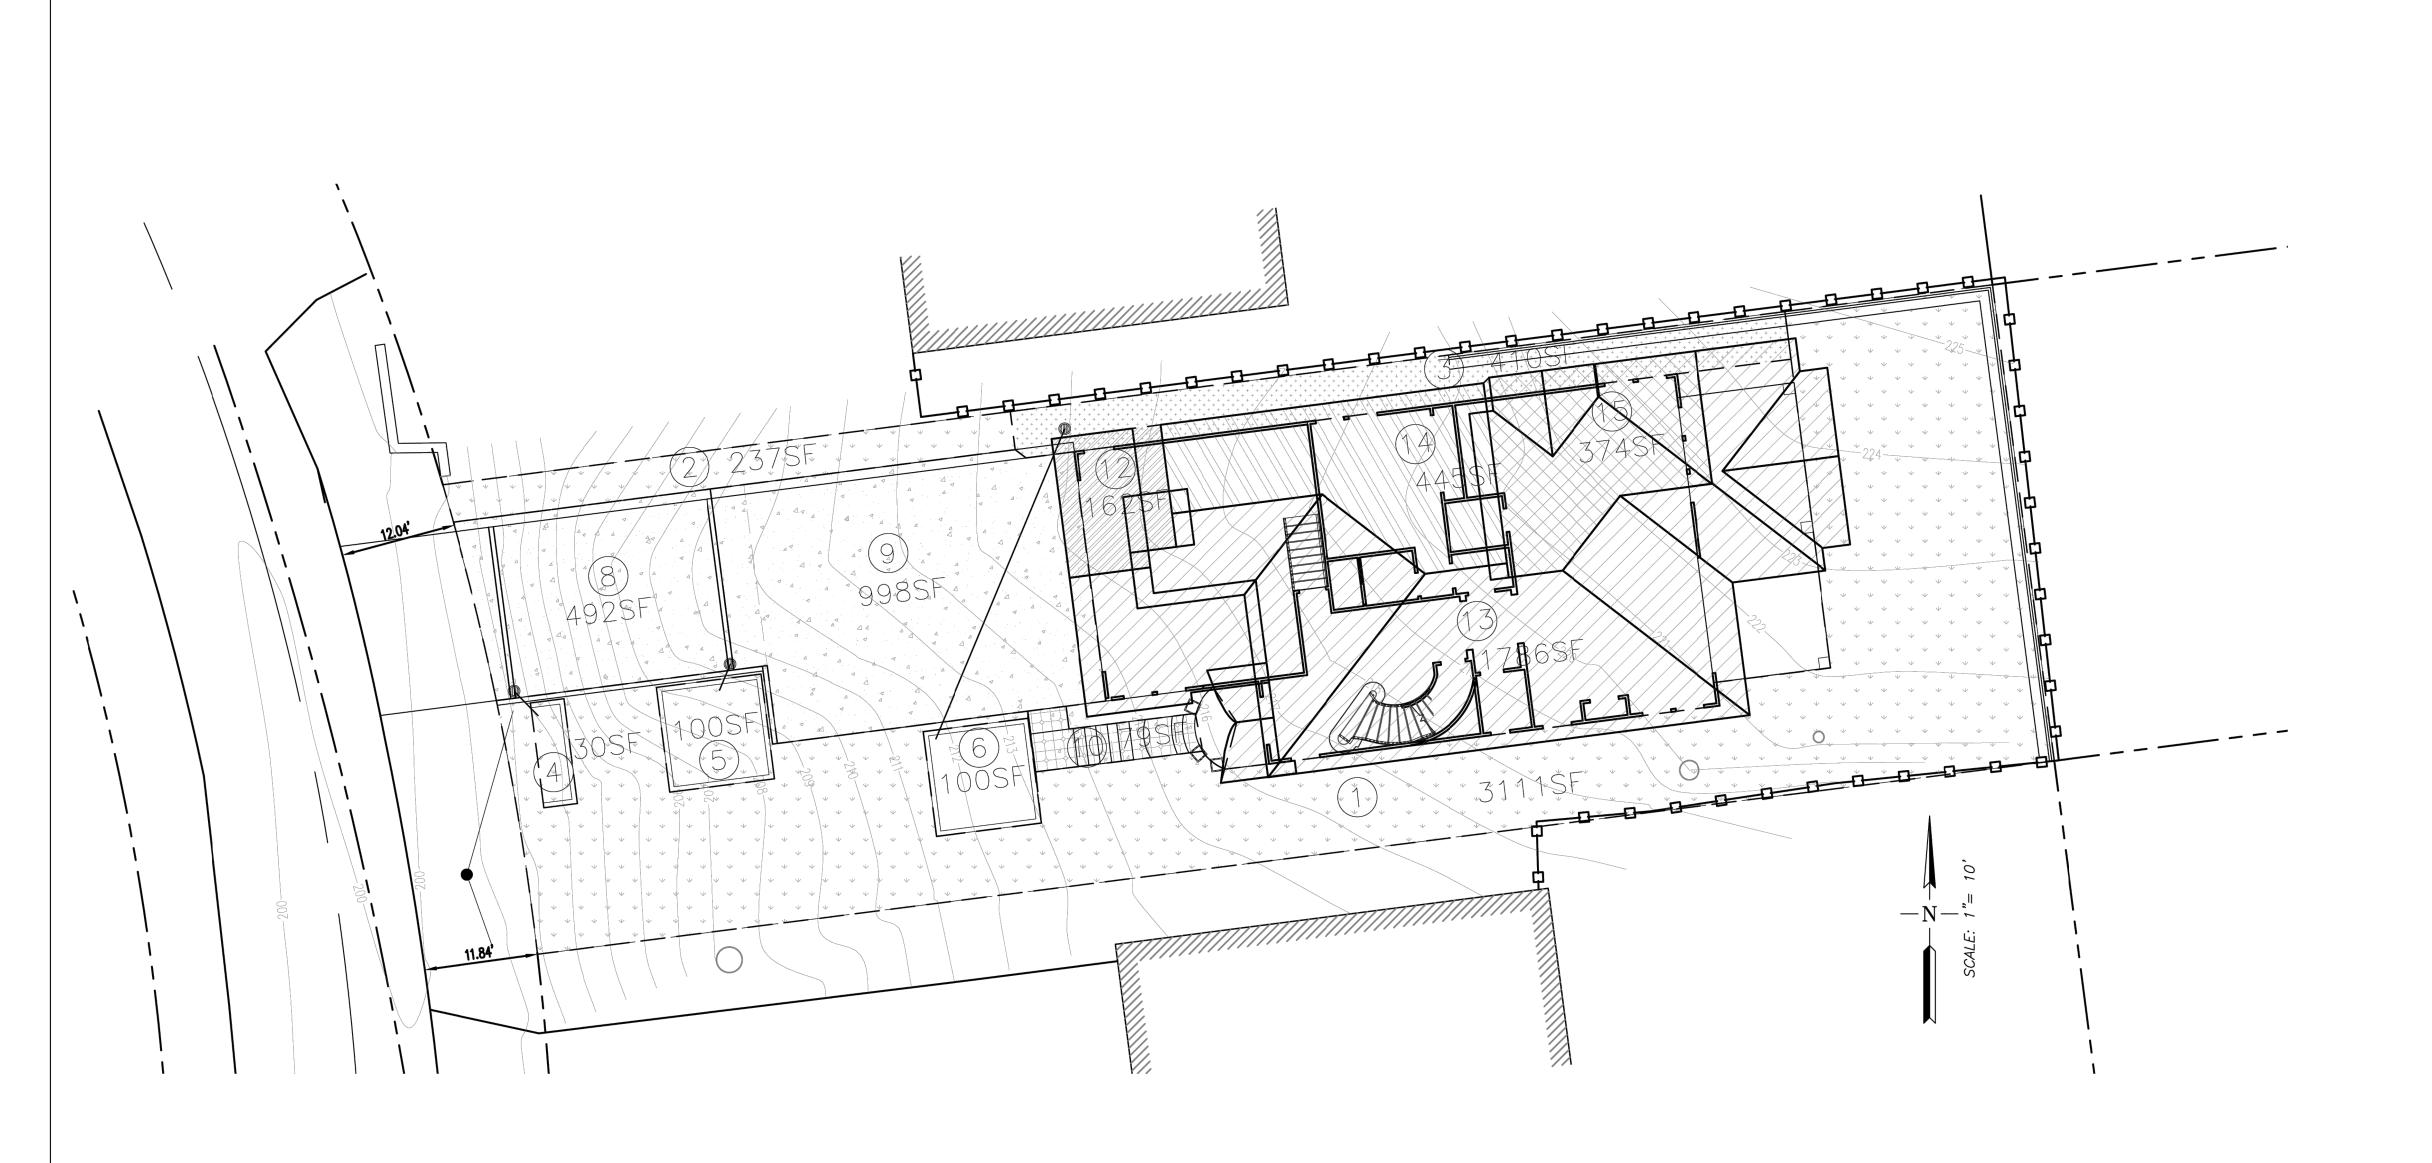

DRAINAGE ARFAS.

DRAINA	GE AREAS:		
AREA:	SQUARE FOOTAGE	TYPE	DRAINS TO AREA
1	3,111 SF	LANDSCAPE	
2	237 SF	LANDSCAPE	
3	410 SF	LANDSCAPE	
4	30 SF	RAIN GARDEN	
5	100 SF	PLANTER BOX	
6	100 SF	PLANTER BOX	
7		DELETED	
8	492 SF	CONCRETE	4
9	998 SF	CONCRETE	5
10	158 SF	CONCRETE	1
11		DELETED	
12	162 SF	ROOF	6
13	1786 SF	ROOF	1
14	445 SF	ROOF	6
15	374 SF	ROOF	3

USPIVA Ingineering CIVIL ENGINEERING CIVIL ENGINEERING

STORM DRAINAGE AREAS
FOR
FOR
APN: 047-222-260
GRANADA CALIFORNIA

EPARED FOR:

JOB NO.

DATE 3-3-24

SCALE NA

DR. BY V.G.D.

CK. BY V.G.D.

PROFESSIONAL TOP CALIFORNIA OF CALIFORNIA

sheet number

4 OF 4

GENERAL NOTES:

1. IT IS THE RESPONSIBILITY OF THE CONTRACTOR TO FIELD VERIFY EXISTING CONDITIONS, THE LOCATION OF ALL TREES WITHIN THE LIMIT OF WORK, UTILITIES, AND ALL SITE ELEMENTS PRIOR TO BEGINNING THE WORK.

2. PERFORM ALL WORK IN CONFORMANCE WITH REQUIREMENTS AND OTHER APPLICABLE CODES, ORDINANCES AND REGULATIONS. OBSERVE ALL SETBACKS SHOWN ON THE PLANS

AND AS OTHERWISE MAY BE REQUIRED.

3. THE LANDSCAPE ARCHITECT AND THE OWNER SHALL BE ADVISED 48 HOURS IN ADVANCE FOR PERFORMANCE OF SITE OBSERVATIONS.

CONSTRUCTION LAYOUT NOTES:

1. THE LAYOUT PLAN IS DIAGRAMMATIC ONLY, SHOULD A
DISCREPANCY EXIST BETWEEN THE PLAN AND ACTUAL SITE
CONDITIONS, THE LANDSCAPE ARCHITECT SHALL BE
NOTIFIED IMMEDIATELY, IN WRITING, PRIOR TO
COMMENCEMENT OF ANY WORK. THE CONTRACTOR IS
RESPONSIBLE FOR:

A. VERIFYING AND CONFORMING TO SETBACKS AND OTHER INDICATED DIMENSIONS.

B. LAYOUT OF ALL MAJOR COMPONENTS PRIOR TO STARTING CONSTRUCTION.

C. COOPERATING WITH LANDSCAPE ARCHITECT AND OWNER IN RESOLVING ANY DISCREPANCIES AND MAKING ADJUSTMENTS TO AVOID ADDITIONAL COSTS TO THE

2. THE LANDSCAPE ARCHITECT SHALL APPROVE ALL STAKE UP AND FORM WORK PRIOR TO INSTALLATION.

3. ALL CURVES SHALL BE SMOOTH AND CONTINUOUS AND ALL

ANGLES SHALL BE 90°, UNLESS OTHERWISE NOTED.
4. WRITTEN DIMENSIONS SHALL PREVAIL. DO NOT SCALE

DRAWINGS, UNLESS OTHERWISE NOTED.

5. ALL RADIUS POINT DISCREPANCIES ARE +/-. ADJUSTMENTS IN THE FIELD MAYBE NECESSARY FOR SMOOTH, EVEN LINES

AND LAYOUT POINTS.

6. ALL DIMENSIONS START AT REFERENCE LINES, FACE OF BUILDING, DESIGNATED RADIUS POINTS, UNLESS

OTHERWISE NOTED.

7. CONTRACTOR SHALL INSTALL EXPANSION JOINTS WITH MASTIC BETWEEN ANY BUILDING AND PAVING CONNECTIONS, AND BETWEEN EXISTING PAVING AND NEW PAVING.

8. CONTRACTOR TO COORDINATE SLEEVING (IRRIGATION, LIGHTING, DRAINAGE, ETC.) WITH OTHER CONTRACTORS

PLANTING LIST

SYMBOL	BOTANICAL NAME - COMMAN NAME	QTY	SIZE	WUCOLS
Tree				
T1	Cupressus sempervirens 'Stricta' - ItalianCypress	3	24" box	L
T2	Lagerstroemia indica x f. 'Muskogee' - Crape Myrtle	2	24" box	L
Shrub	OS CONTRACTOR OF THE PROPERTY			
Ac	Acaccia cognata 'Cousin Itt' - Cousin Itt River Wattle	4	5 gallon	L
AL	Alyogyne huegelii 'Monterey Bay' - Blue Hibiscus	7	5 gallon	L
Cs	Cistus x skanbergii - Pink Rockrose	12	5 gallon	L
CE	Ceanothus gloriosus 'Anchor Bay' - Wild Lilac	14	5 gallon	L
Di	Dietes iridioides - African Iris	5	5 gallon	L
He	Heteromeles arbutifolia - Toyon	5	5 gallon	L
Ls	Lavandula stoechas 'Javelin Forte' - Spanish Lavender	10	1 gallon	L
Pr	Prunus caroliniana - Carolina Cherry Laurel	11	15 gallon	L
Ro	Rosmarinus officinalis 'Tuscan Blue' - Rosmary	8	5 gallon	L
Bioret	ention Area Planting (*)			•
Во	Bouteloua gracilis 'Blonde Ambition' - Blue Grama	13	1 gallon	L
Ct	Chondropetalum tectorum - Cape Reed	7	1 gallon	L

- WUCOLS CATEGORIES OF WATER NEEDS: VL = VERY LOW, L = LOW WATER USE, M = MODERATE WATER USE

* PLANT SUITABLE FOR BIORETENTION AREA FROM PLANT LIST FOR STORMWATER MEASURES. Grasses shall be planted in basin and shurbs in the bank of biorention area. (C3 Technical Guidance Manual)

PLANTING NOTE:

- 1. Before planting till the following materials into the top 6" of soil (for each 1,000 S.F.):
 - a. 6 cubic yards green waste compost
 - b. 10 LB fertilizer (N16/P6/K8) w/ 2% iron
- c. 5 LB sulfate of ammonia
 2. Mulch all exposed soil surfaces of the planting areas with a 3" thick layer of medium recycled
- wood chips, color 'Dark Brown'.
 3. For trees, nursery stakes shall be removed at the time of planting. Stake each tree using 2 lodge
- poles and rubber tree ties.
 4. The Landscape Architect and the Owner reserve the right to reject any or all plant material, if such material does not meet the American Standards for Nursery Stock (ANSI). Plant materials shall
- material does not meet the American Standards for Nursery Stock (ANSI). Plant materials shall be guaranteed against latent defects, injuries, pests, diseases or death of plants due to improper planting. The Contractor shall promptly replace plants that have died or are not in a vigorous, healthy condition with plants of the same kind and size as originally specified at no expense to the Owner.
- 5. Landscape Architect to approve plant locations prior to planting.
- 6. The Contractor shall be responsible to continuously maintain grades, plant material, and irrigation through the maintenance period until final acceptance of the work by the Owner.
- 7. The Contractor shall be responsible for the adequate protection of the improvements. Damaged areas, such as sprinkler heads or plant materials, shall be replaced or repaired at no additional expense to the Owner.

I HAVE COMPLIED WITH THE CRITERIA OF THE ORDINANCE AND APPLIED THEM FOR THE EFFICIENT USE OF WATER IN THE LANDSCAPE DESIGN PLANS.

augither

11/8/2022

LANDSCAPE ARCHITECT SIGNATURE

PROJECT INFORMATION

PROJECT ADDRESS: FERDINAND AVE. EL GRANADA, CA APN 047-222-260

TOTAL LANDSCAPE AREA: 1778 SF PROJECT TYPE: RESIDENTIAL NEW LANDSCAPE, WATER SUPPLY TYPE: POTABLE WATER.

TOTAL PLANTING AREA EXCLUDING EDIBLES:

1778 SF (100%)

PLANTING AREA INSTALLED WITH CLIMATE

LITTLE OR NO SUMMER WATER: 1778 (100%)

ADAPTED PLANTS THAT REQUIRE OCCASIONAL

TOTAL TURF AREA: 0%

MORE THAN 75% OF PLANTING USES PLANTS THAT REQUIRE OCCASIONAL, LITTLE OR NO SUMMER WATER.

LANDSCAPE DESIGN PLAN (TITLE 23, CHAPTER 2.7):

RECIRCULATING WATER SYSTEMS SHALL BE USED FOR WATER FEATURES

A MINIMUM 3-INCH LAYER OF MULCH SHALL BE APPLIED ON ALL EXPOSED SOIL SURFACES OF PLANTING AREAS EXCEPT TURF AREAS, CREEPING OR ROOTING GROUNDCOVERS, OR DIRECT SEEDING APPLICATIONS WHERE MULCH IS CONTRAINDICATED.

FOR SOIL LESS THAN 6% ORGANIC MATTER IN THE TOP 6 INCHES OF SOIL, COMPOST AT A RATE OF A MINIMUM OF FOUR CUBIC YARDS PER 1,000 SQUARE FEET OF PERMEABLE AREA SHALL BE INCORPORATED TO A DEPTH OF SIX INCHES IN TO THE SOIL.

AT THE TIME OF FINAL INSPECTION, THE PERMIT APPLICANT MUST PROVIDE THE OWNER OF THE PROPERTY WITH A CERTIFICATE OF COMPLETION, CERTIFICATE OF INSTALLATION, IRRIGATION SCHEDULE AND A SCHEDULE OF LANDSCAPE AND IRRIGATION MAINTENANCE.

Signature
5/30/2023
Renewel Date
2/6/2023
Date
OF CALIFORNIE

UNDERGROUND SERVICE
ALERT (USA) - 800-227-2600
CALL BEFORE YOU DIG.
CONTRACTOR TO CALL USA 2 DAYS BEFORE
EXCAVATION TO LOCATE UNDERGROUND

SHEET INDEX

L-1 LANDSCAPE PLAN

UTILITIES.

L-2 LANDSCAPE IRRIGATION PLAN

L-3 HYDROZONE MAP AND WELO WORKSHEET

DATE: 11/8/2022 SCALE: 1/8" = 1'-0" DRAWN BY: AH PROJECT # 21045 SHEET

L - 1
TOTAL SHEETS: 3

2647 ROYAL ANN DRIVE UNION CITY, CA 94587 anyi@anyilandscape.com 650-533-0107


LANDSCAPE STUDIO

REVISION DATE | NO.

2/6/2023

10/3/2023

EET TITLE:

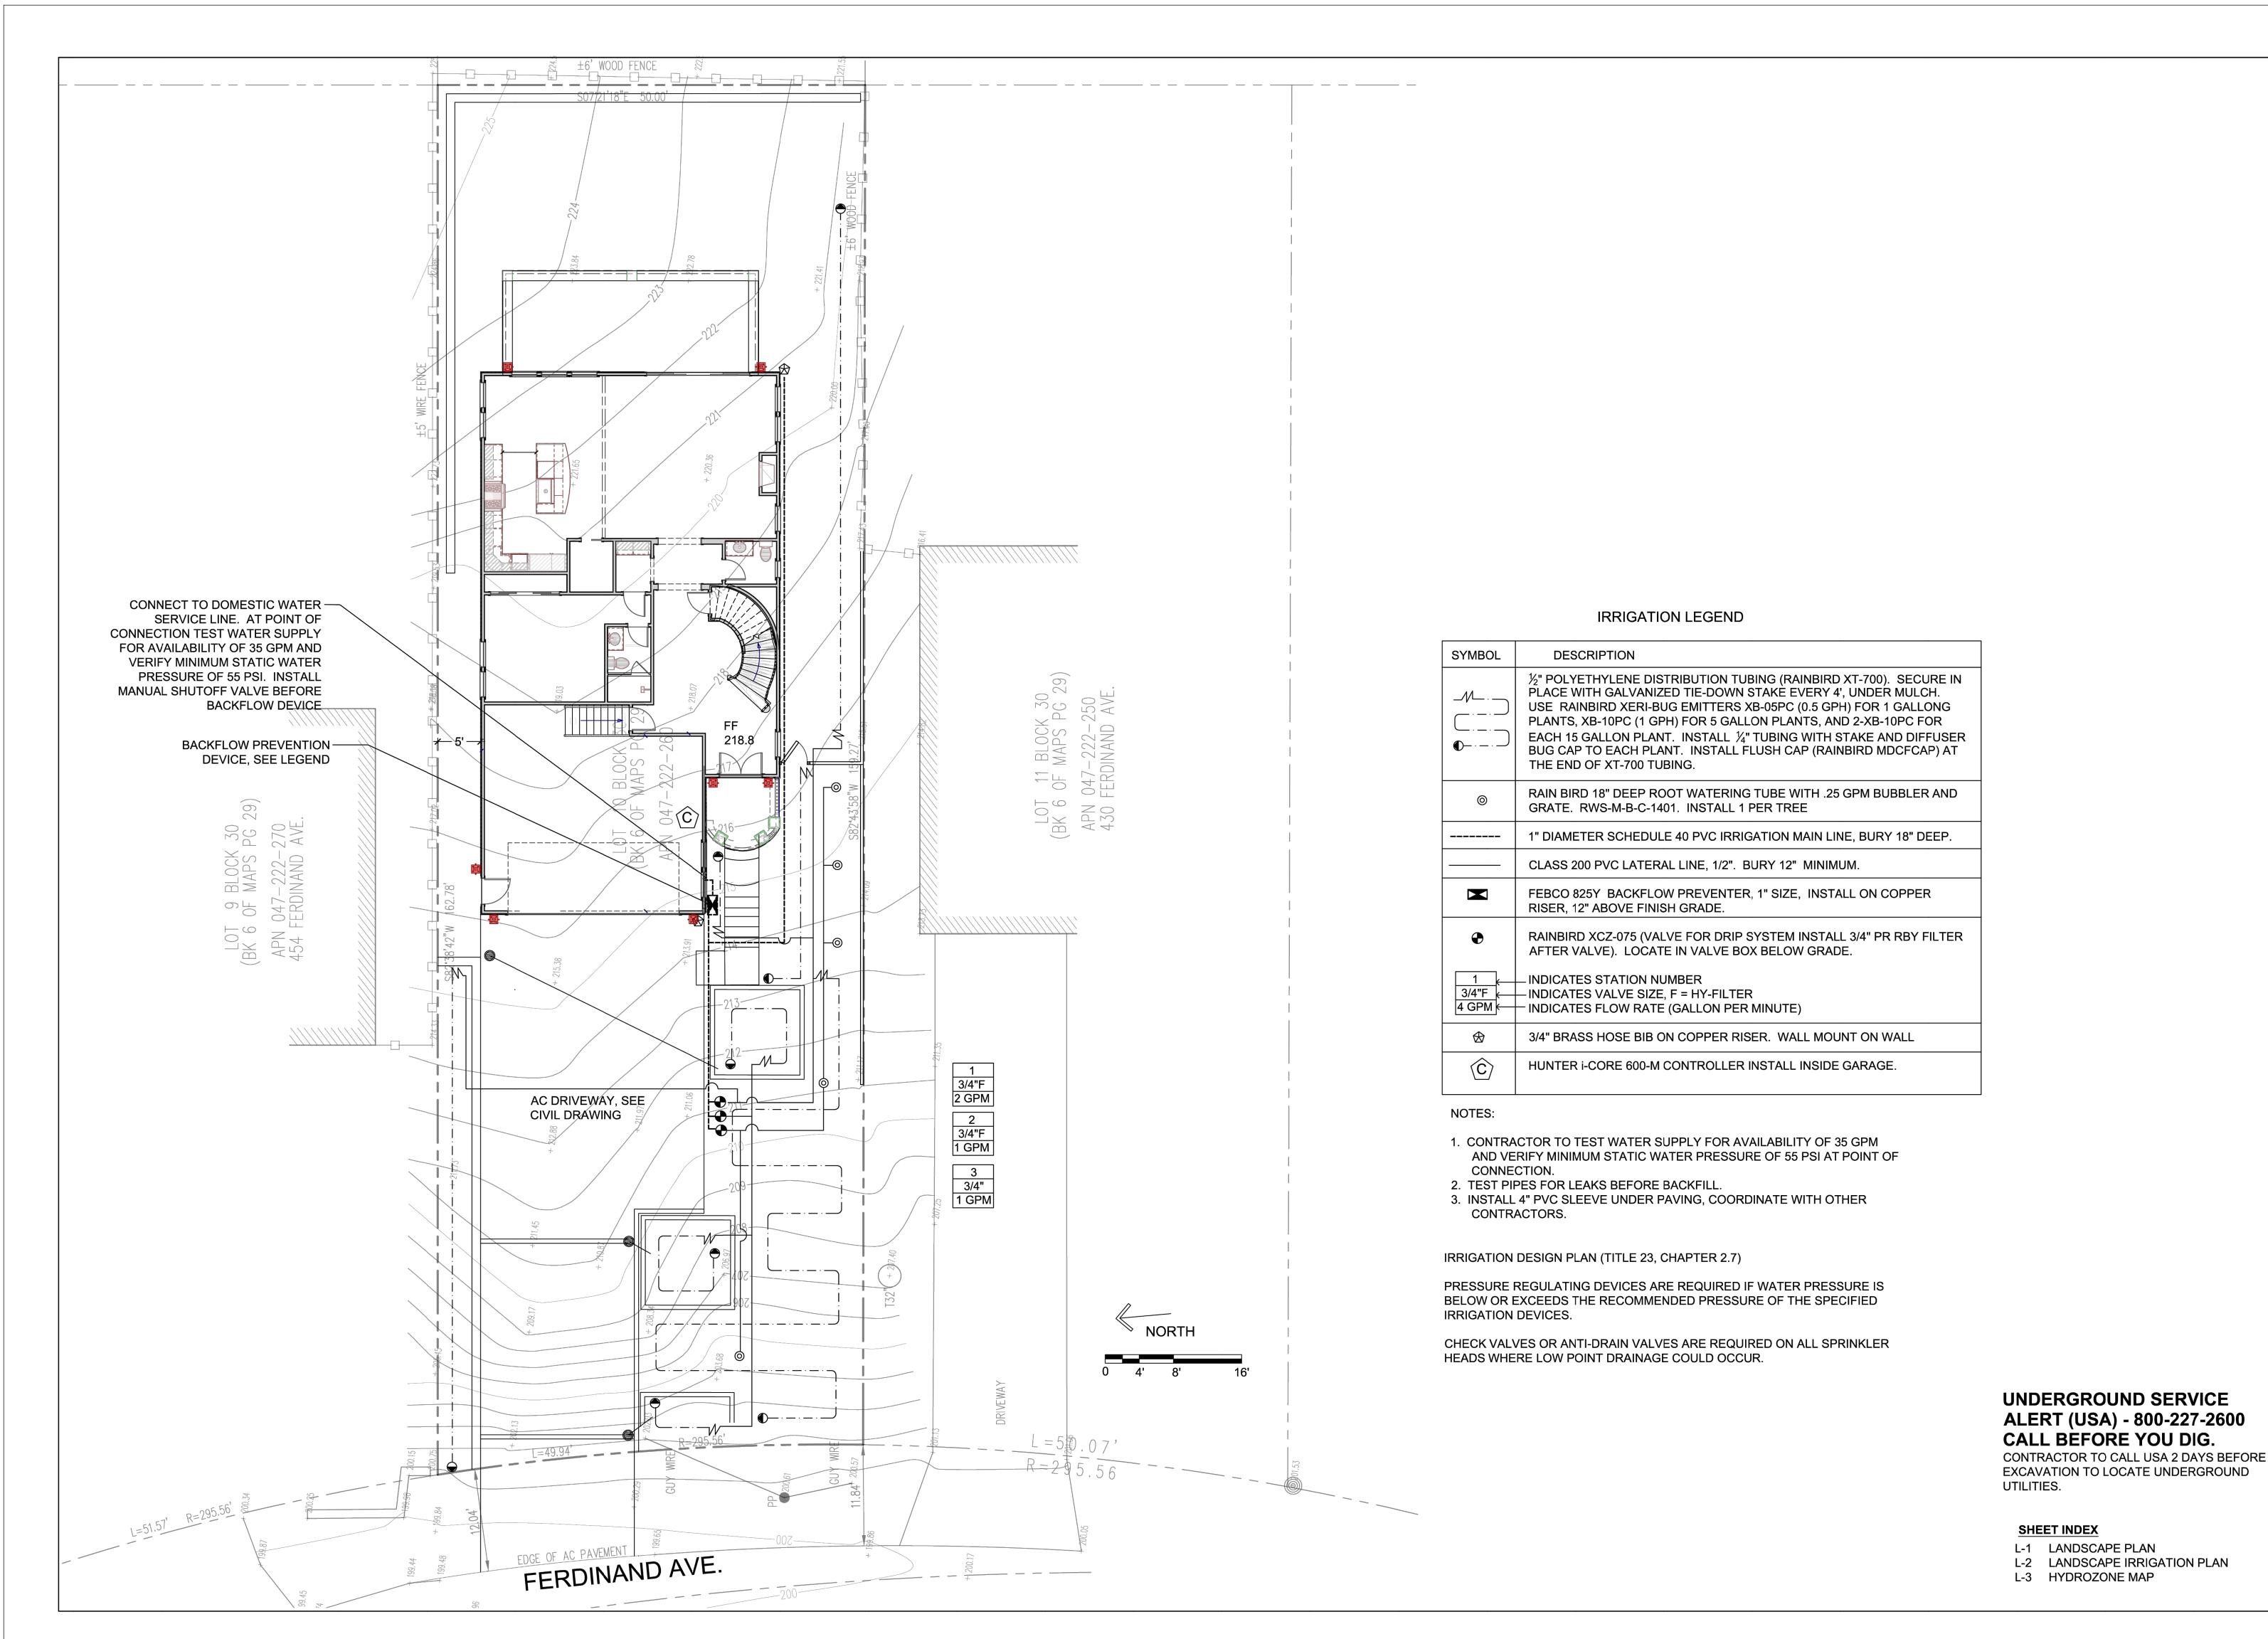

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2647 ROYAL ANN DRIVE UNION CITY, CA 94587 anyi@anyilandscape.com 650-533-0107

REVISION DATE | NO.

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Sidnature
5/30/2023
Renewal Date
2/6/2023
Date
OF CALIFORNIE


PROJECT ADDRESS:
FERDINAND AVE.

DATE: 11/8/2022 SCALE: 1/8" = 1'-0"

DRAWN BY:
AH
PROJECT #

21045 SHEET

TOTAL SHEETS: 3

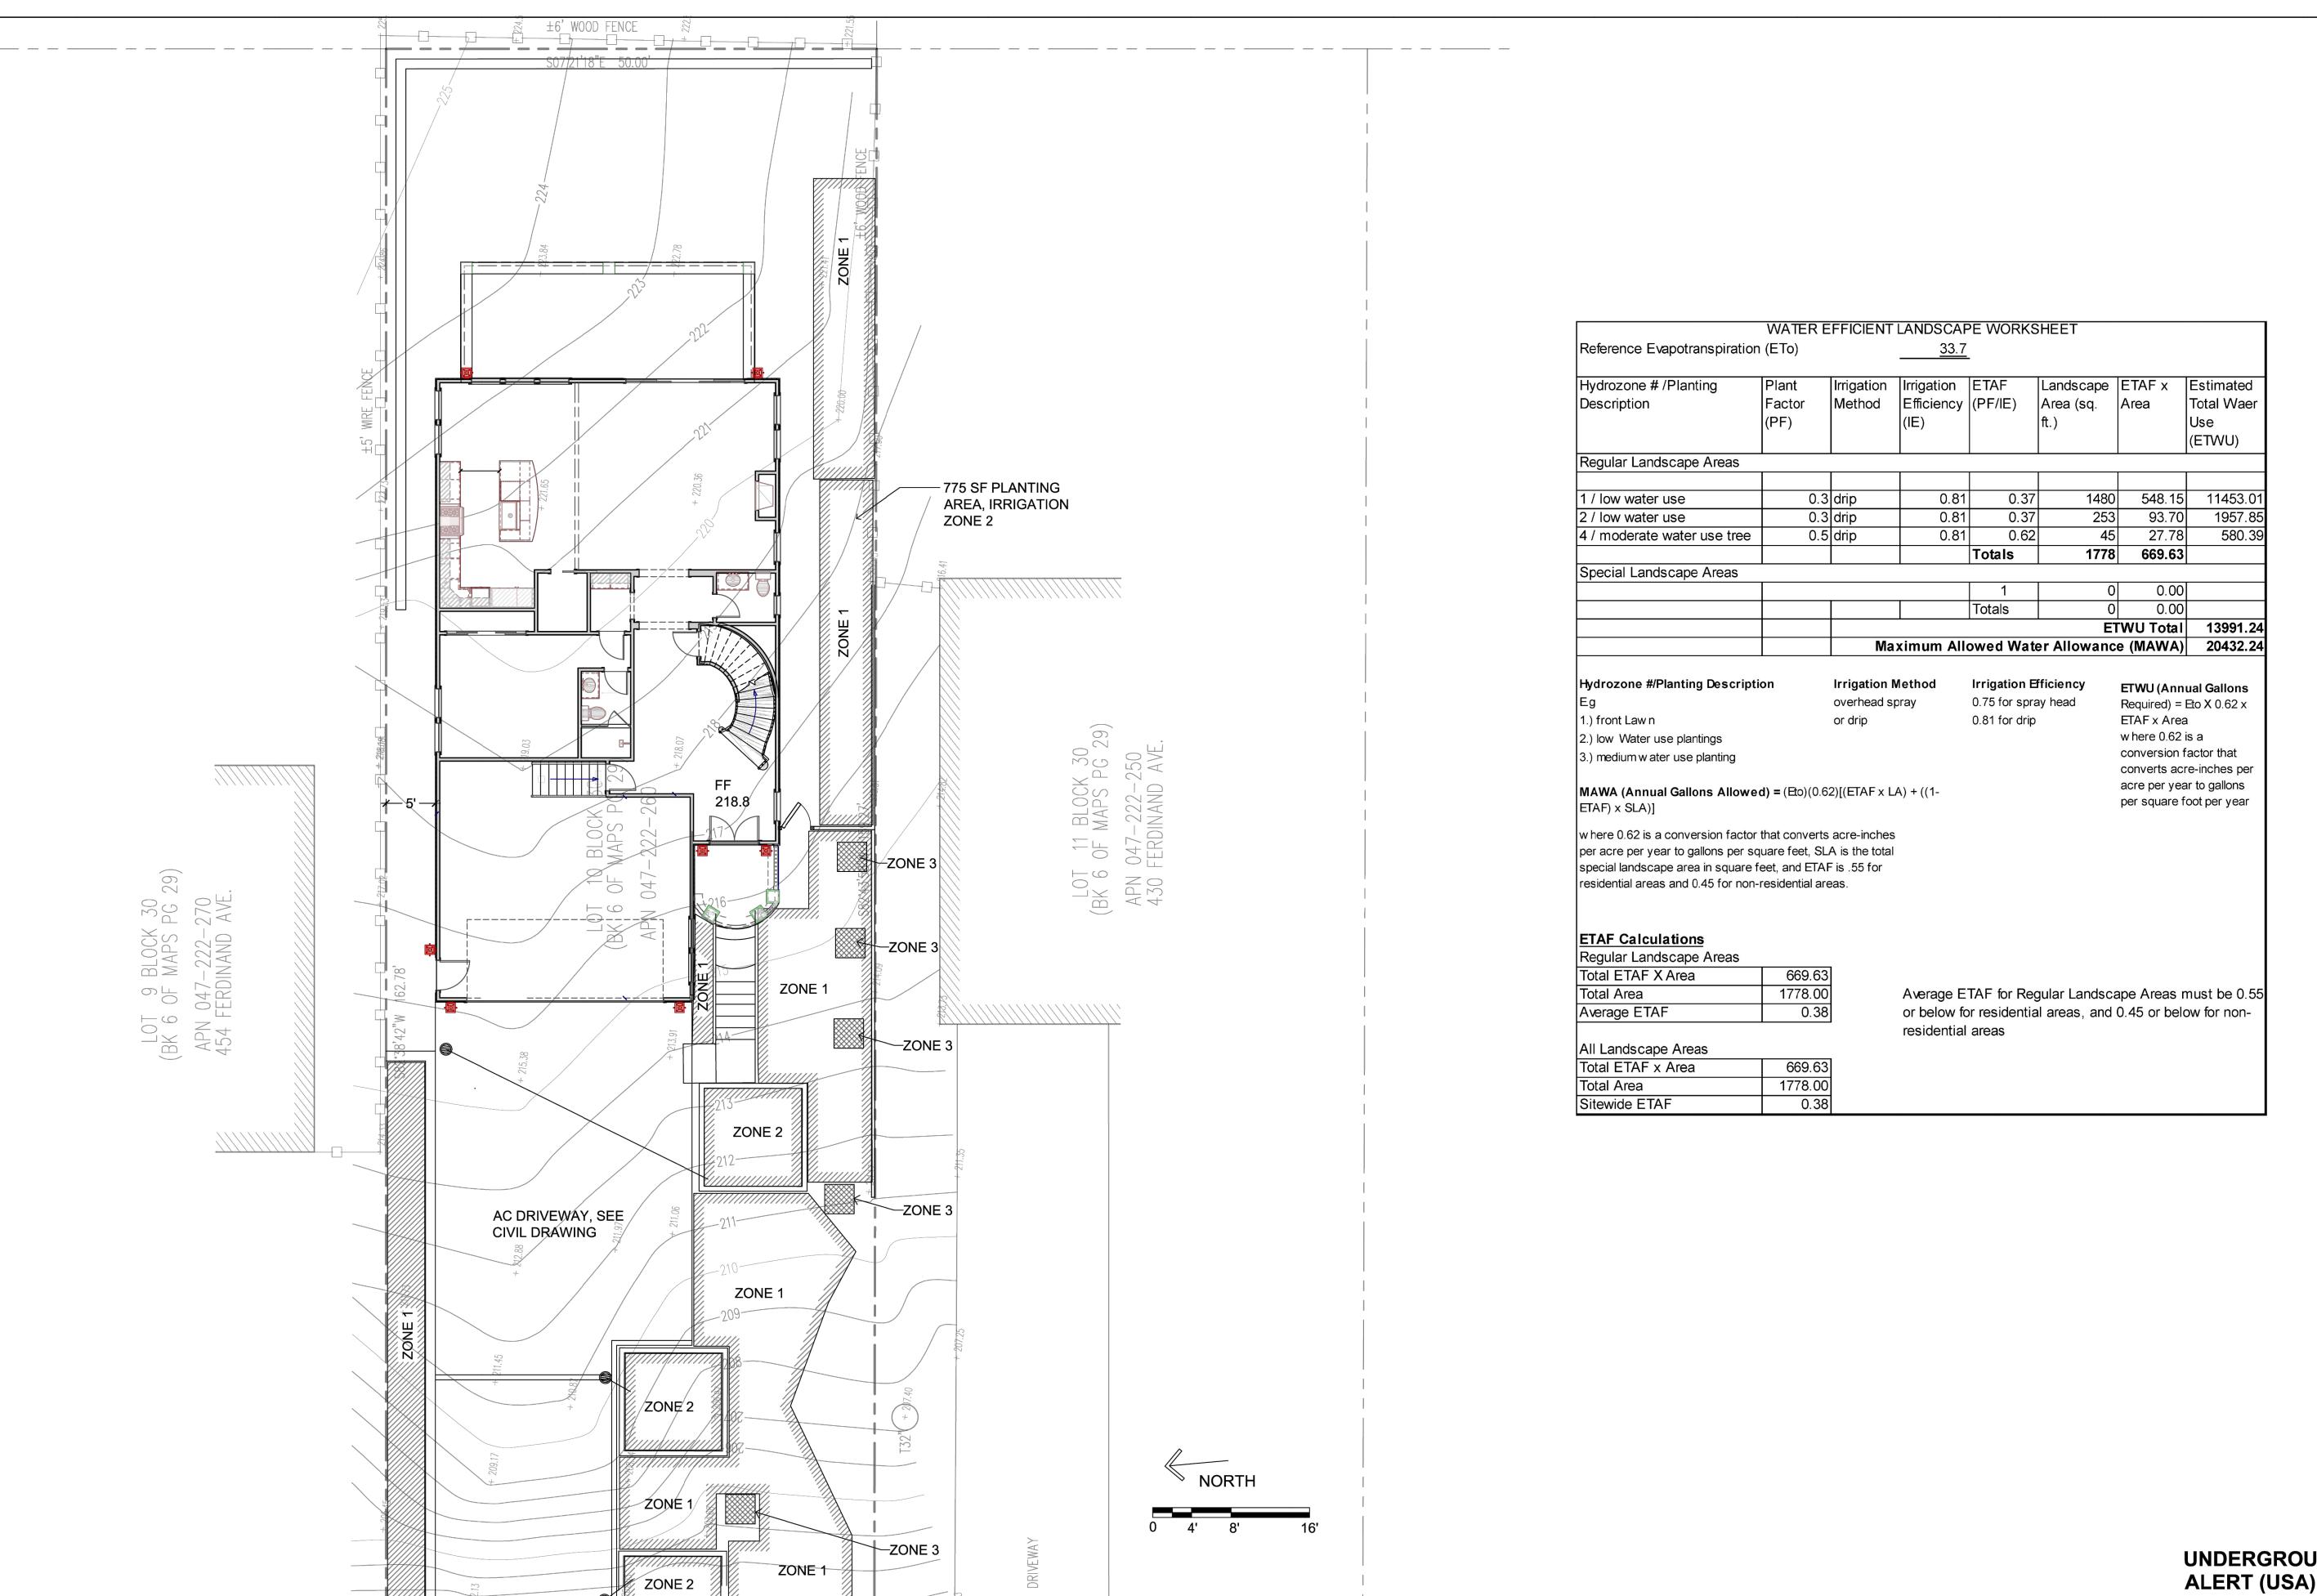

FERDINAND AVE.

UNDERGROUND SERVICE **ALERT (USA) - 800-227-2600 CALL BEFORE YOU DIG.**

CONTRACTOR TO CALL USA 2 DAYS BEFORE EXCAVATION TO LOCATE UNDERGROUND UTILITIES.

SHEET INDEX

- L-1 LANDSCAPE PLAN
- L-2 LANDSCAPE IRRIGATION PLAN

L-3 HYDROZONE MAP

LANDSCAPE STUDIO

2647 ROYAL ANN DRIVE UNION CITY, CA 94587 anyi@anyilandscape.com 650-533-0107

REVISION DATE NO.

Q AND HYDROZONE I WORKSHEET



DATE: 11/8/2022

SCALE: 1/8" = 1'-0" DRAWN BY:

 AH PROJECT#

21045 SHEET

L - 3 TOTAL SHEETS: 3



CLEARLY SUPERIOR









UNDERSTANDING WINDOW PERFORMANCE

To know if you are getting stable, energy efficient, high performance windows, you can rely on word of mouth or worse believe every claim a manufacturer makes; but the wise consumer utilizes third party verification. The American Architectural Manufacturers Association (AAMA) and the National Fenestration Ratings Council (NFRC) are the predominant organizations that provide testing standards for the window industry. Look for certified AAMA and NFRC testing results to really understand if your window is energy efficient and structurally sound.



BOLD COLORS

Choose black, bronze, white or adobe or ask about our custom color options.

Our color choices will enhance or complement any project.

*Please review actual color samples prior to selection.



CLEAN LINES

No ugly accessory lines keep your view clean and clear.



DURABLE

Optional foam filled frames help prevent heat distortion. Steel reinforced interlocks provide large windows with more strength than any vinyl, wood or composite framing alone can provide. Welded corners help reduce moisture intrusion.

All Coeur d'Alene Windows are made from extruded PVC with additives to enhance weatherability. In building products, longevity is often directly related to how well a product resists moisture intrusion; PVC has vastly superior moisture resistance to either wood or wood-flour based composites.



The 1000 Series Window features a 2 ¾" wide frame well suited for new construction and many aluminum window replacement applications. The 1000 Series is available in single-hung, picture and sliding configurations to complement most design choices.



1121* SLIDING WINDOW

2.2mm/3mm Glass	4mm/3mm Glass	2.2mm/2.2mm Glass	2.2mm/2.2mm Glass
Foam in Frame	Foam in Frame		
Argon Gas	Argon Gas	Argon Gas	Argon Gas
LoĒ ³ -270®	Lodz-366®	LoĒ3-366®	LoĒ ³ -270®
Indium			

*This is only a sample of test result, please consult the NFRC Certified Products directory or a customer service rep for complete testing information



1000 SERIES AAMA PERFORMANCE TESTING

Model	Description	Grade / Test Size
1010	Picture Window	LC PG-55 (55X55)
1121	Single-slide Window	LC PG-35 (71X55)
1221	Single Hung Window	LC PG-40 (44X75)













At 3 3/8" wide, the 3000 Series is our most popular solution for today's demanding environments. The 3000 Series features a heavy extruded frame and fixed interlock for added stability. Making a stronger, more durable window may go against the trend, but we

tend to be a little different at Coeur d'Alene.



3121* SLIDING WINDOW

Indium			
LoĒ3-270®	LoĒ3-366®	LoĒ3-366®	LoĒ3-270®
Argon Gas	Argon Gas	Argon Gas	Argon Gas
Foam in Frame	Foam in Frame		
2.2mm/3mm Glass	4mm/3mm Glass	2.2mm/2.2mm Glass	2.2mm/2.2mm Glass

U-Value	.24	.28	.29	.30	
SHGC	.30	.23	.22	.30	

^{*}This is only a sample of test result, please consult the NFRC Certified Products directory or a customer service rep for complete testing information



3000 SERIES AAMA PERFORMANCE TESTING

Model	Description	Grade / Test Size
3310	Picture Window	LC PG-55 (55X55)
3121	Single-slide Window	LC PG-35 (71X55)
3221	Single Hung Window	LC PG-40 (44X75)















Coeur d'Alene 3000 Series Casement and Awning Windows are designed to be thermally efficient, easy to operate, look good and thrive in severe environments. Rigid PVC and thoughtfully engineered hardware provide the strength necessary for worry-free operation. Standard multi-point locks provide added security.



3411* CASEMENT WINDOW

LoĒ3-270®	Indium	
LoĒ3-180®	LoĒ3-366®	LoĒ3-270®
Argon Gas	Argon Gas	Argon Gas
2mm/2mm2/2mm Glass	3mm/3mm	2mm/2mm

U-Value	.18	.24	.28	
SHGC	.23	.19	.26	

^{*}This is only a sample of test result, please consult the NFRC Certified Products directory or a customer service rep for complete testing information



3000 SERIES CASEMENT AAMA PERFORMANCE TESTING

Model	Description	Grade / Test Size
3411	Single Casement	PG-55 (32x59)
3511	Single Awning	PG-55 (47.25x31.5)

^{*} Ask about our PG 85 option for rugged environments and commercial applications















Coeur d'Alene Double-slide and Double-hung Windows are designed specifically for today's demanding environment. The double-hung features side-load removable sashes, allowing for a stronger more resilient frame than East Coast tilt-in designs. Double-hung and double-slide windows from The Coeur d'Alene Window Company

provide for a traditional equal sight line view.



4622* DOUBLE-HUNG WINDOW

Indium		
LoĒ3-366®	LoĒ3-366®	LoĒ3-270®
Argon Gas	Argon Gas	Argon Gas
& Foam		

U-Value .24 .30 .30 .30 SHGC .20 .24 .27

^{*} This represents the most popular options with standard glass thickness, please check NFRC.org for a complete list of results with options.

Model	Description	Grade / Test Size
4622	Double-hung	LC PG 45 (44 X 75)
4722	Double Slide	LC PG 35 (72 X 56)

Stylish
Beveled
Exterior True
Equal-Sight
Glass













PATIO DOOR 5800 SERIES WIDE RAIL PATIO DOOR

The Wide Rail Patio Door from Coeur d' Alene features the clean bold lines of a French door without the hassle of operation or the space constraints associated with swinging door products. The door also features foam filled framing and a heavy-duty extruded sliding screen door.



5821 WIDE RAIL DOOR*

3821 / 5821

3821 MODERN RAIL DOOR

3842 / 5842

1	Lodz-366® Argon Gas	Lodz-366® Argon Gas
U-Value	.23	.26
SHGC	.18	.19
-	1774000	

	Lodz-366® Argon Gas	Lodz-366® Argon Gas
J-Value	.23	.27
NICO.	22	22

3831 / 5831

Model	Description	Grade / Test Size
3821	Patio Door	LC PG 30 (87 X 87)
5821	Patio Door	LC PG 25 (87 X 87)

3821T / 5821T





3800 SERIES MODERN RAIL DOOR

The Modern Rail Patio Door features maximum viewing area for today's contemporary homes. The sleek looks of the Modern Rail Door minimize the frame allowing you to take in the view. The Modern Door comes standard with a sleek roll formed screen. Additional options are available.
















OBSCURE GLASS

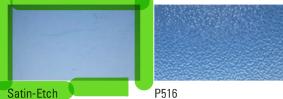





Glue Chip



#42 Clear



Narrow Reed

Delta Frost




Seedy / Reamy



Rain



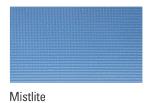






Cross Reed 5/8"

LIGHT COMMERCIAL APPLICATIONS

The Coeur d'Alene Window Company produces a number of products ideally suited for the light commercial, multi-family and mixed-use markets. Offerings include a wide array of colors that are among the industry's most energy efficient products without sacrificing structural performance. Ask your sales representative about your next project.

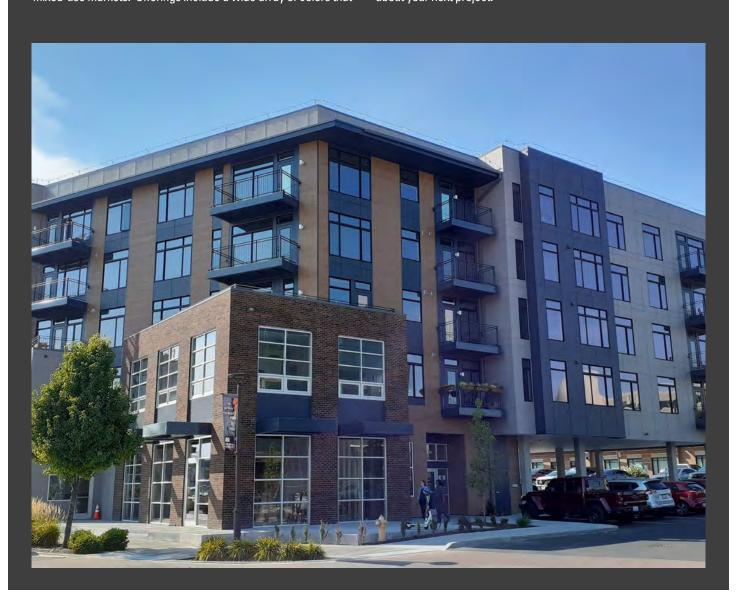





NEAT® GLASS

Coeur d'Alene Windows is pleased to offer NEAT® glass as an option. Neat®'s hydrophilic sheeting process keeps your windows cleaner longer.



INDIUM

Upgrade your Coeur d'Alene Windows and make them even more energy efficient by adding Indium coated glass from Cardinal® IG.



PRESERVE®

Many windows show up to the home covered with finger prints, dirt, and scratches. When you buy new windows, you expect them to be in good condition.

Preserve® Protective Film is placed on the interior and exterior of the Insulating Glass unit immediately after the glass unit is made to make sure that your new windows are delivered to you with care, clean and clear.

water

ORDINARY

and sheets off quickly

HYDROPHOBIC:

Water beads up and resists flow



ENDUR IG®

- **Primary Seal:** Polyisobutylene (PIB) minimizes moisture permeation, is UV resistant and provides an outstanding argon barrier.
- 2 Secondary Seal: Specially formulated silicone for IG units provides long-term adhesion, is unaffected by UV exposure and provides excellent durability when exposed to moisture. Silicone also provides structural integrity.
- **Spacer:** Stainless steel spacer features a roll form design to provide maximum area for primary and secondary sealant coverage. It provides increased resistance to condensation and less stress on IG seal system. No polymer content eliminates the risk of chemical fogging.
- **Desiccants:** Beaded molecular sieve provides initial frost points below -65°F. Desiccant assures optimum moisture adsorption while minimizing the effects of temperature-related pressure changes.



COLORS

Coeur d'Alene Windows are available in a number of exterior colors including white, adobe, bronze and black. We also offer interior finishes and a large selection of custom colors. Please refer to our finishes brochure. Coeur d'Alene maintains it's own in house finishing production facility. We hold certifications from both AAMA and our suppliers.

*Please review actual color samples prior to selection.



Patio Door Multi-Point Lock

HARDWARE

Our casement and awning windows include nesting hardware that folds into the housing, keeping the hardware out of the way. This hardware is available in white, adobe, oil-rubbed bronze or nickel.



Coeur d'Alene sliding and hung windows include standard camlocks in white or adobe. Ready for a contemporary alternative? Try our sleek auto-lock available in white, adobe, oil-rubbed bronze or nickel.







White Auto-lock

Adobe Auto-lock

Nickel Auto-lock





Oil-Rubbed Bronze Auto-lock


Camlock





A SAMPLING OF STYLES AND CONFIGURATIONS.


Please see a Coeur d'Alene representative for a complete selection.

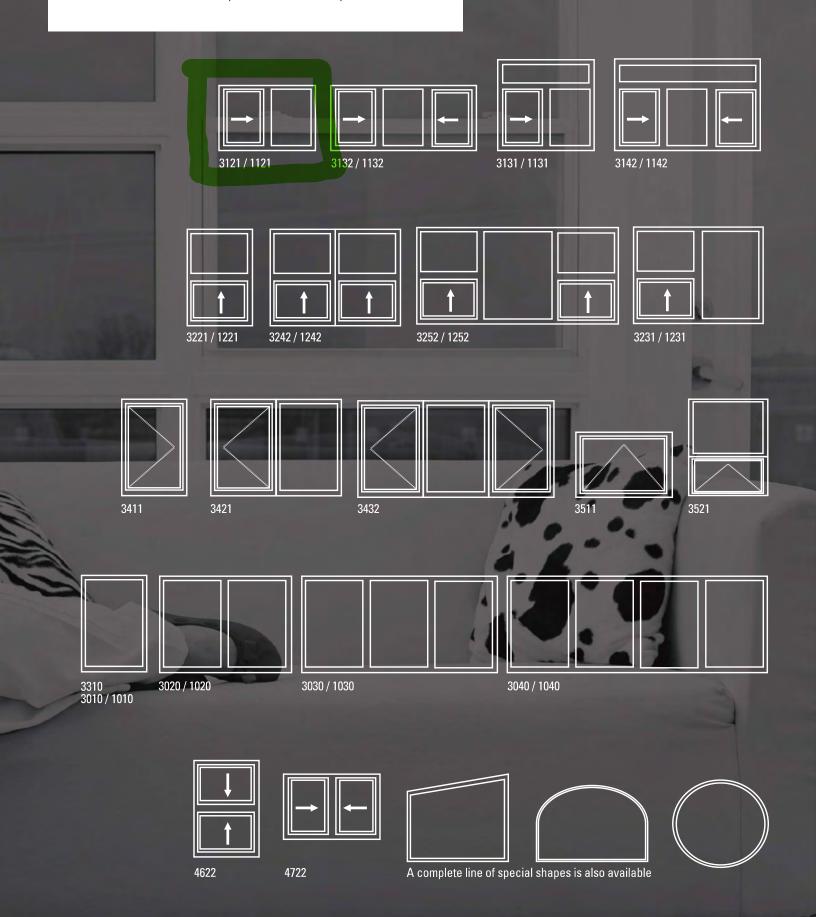





Coeurd Alene Window.com

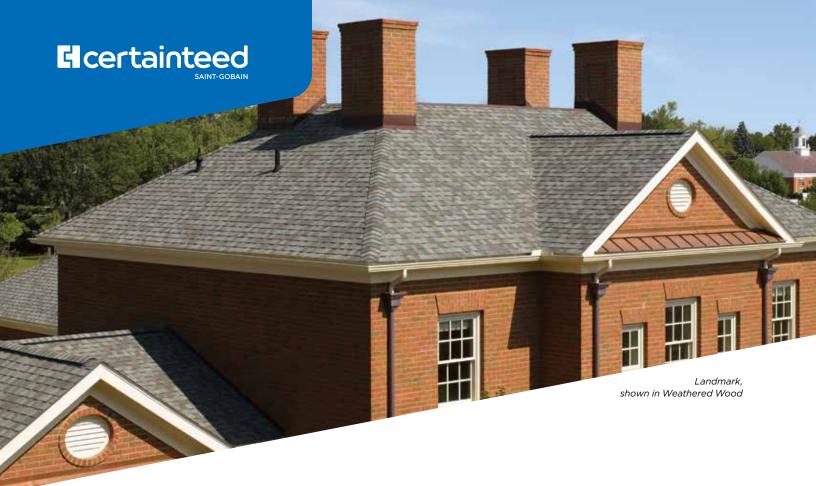

Landmark®

Designer Roofing Shingles

A Classic Original

Landmark's dual-layered construction provides depth and dimension, along with extra protection from the elements. Widest array of colors in the industry.

- Lifetime limited warranty
- 10-year SureStart protection Includes materials and labor costs
- 15-year 110 MPH wind warranty Upgrade to 130 MPH available
- CertaSeal® seals roofs tight against wind and weather.
- **Streak**Fighter 10-year algae resistance.
- QuadraBond[®] secures shingle layers together at four points for greater performance.
- Nail Trak® wider nailing area for a more accurate installation

CertainTeed products are tested to ensure the highest quality and comply with the following industry standards:

Fire Resistance:

- UL Class A
- UL certified to meet ASTM D3018 Type 1

Wind Resistance:

- UL certified to meet ASTM D3018 Type 1
- ASTM D3161 Class F

Tear Resistance:

- UL certified to meet ASTM D3462
- CSA standard A123.5

Wind Driven Rain Resistance:

• Miami-Dade Product Control Acceptance

Acceptance Quality Standards:

• ICC-ES-ESR-1389 & ESR-3537



LANDMARK® COLOR PALETTE







er Moiré Black







Weathered Wood Heather Blend Burnt Sienna



Scan code for more information

NOTE: Due to limitations of printing reproduction, CertainTeed can not guarantee the identical match of the actual product color to the graphic representations throughout this publication.



